# SOFT-STORY SEISMIC RETROFIT

# 17 HOFF STREET

231 W. 41ST AV SAN MATEO, CA 650-638-9546  ELOCATION  No C-3862 EXPIRES 3/31  CIVIL OF CALIF  This drawing, as an instrume and shall remain the pr Engineers and shall not be published or used in any permission of the Engineer.  DRAWINGS	ATEO, CA 9 8-9546
No C-3862 EXPIRES 3/31  CIVIL  This drawing, as an instrume and shall remain the proposition of the Engineer.  Division St. 433C	. 7
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# W. CHARLES



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5-23-14

# **SEISMIC RETROFIT DESIGN CRITERIA:**

1. FEMA P807

# **SEISMIC LOADS:**

- 1. LONGITUDE -122.42; LATITUDE 37.76
- 2.  $S_s = 1.500 G$
- 3. S1 = 0.710 G
- 4. FA = 1.0 5. FV = 1.5
- 6. SOIL SITE CLASS D
- 7. SEISMIC DESIGN CATEGORY D
- 8. SDS = 1.0 G
- 9. SD1 = 0.710 G
- 10.  $SM_s = 1.500 G$
- 11. SM₁ = 1.066 G 12. R = 2.0 (EXISTING)
- 13.  $\Omega$  = 2.5 (EXISTING)
- 14.  $C_o = 2.0$  (EXISTING)
- 15. p = 1.3

# **GYPSUM WALLBOARD:**

- 1. INSTALL SHEETS WITH LONG SEAMS PARALLEL TO STUDS/JOISTS.
- 2. ATTACH TO STUDS/JOISTS W/ 1 1/4" DRYWALL SCREWS @ 6" O.C. MAX. COUNTER SINK HEADS. DO NOT TEAR PAPER.
- 3. TAPE & FLOAT ALL JOINTS
- 4. TEXTURE TO MATCH (E) FINISH.
- 5. ALL WORK SHALL COMPLY WITH USG GYPSUM CONSTRUCTION HANDBOOK

# **GENERAL NOTES & REQUIREMENTS:**

- 1. COMPLY WITH ALL CODES INCLUDING 2013 CALIFORNIA STATE BUILDING CODE, 2013 CALIFORNIA STATE PLUMBING CODE, CALIFORNIA STATE MECHANICAL CODE, CURRENT CITY CODES, TITLE 24, UMC, NEC, UPC, PG&E REQUIREMENTS, 2013 CALIFORNIA STATE ELECTRICAL CODE, AND 2013 SAN FRANCISCO BUILDING CODE
- 2. DO NOT SCALE DRAWINGS.
- 3. PROTECT ADJACENT PROPERTY AND IMPROVEMENTS. REPLACE DAMAGED ADJACENT
- 4. PROVIDE ALLOWANCES FOR FINISHES, PER OWNER'S SPECIFICATIONS AND APPROVAL (AS
- 5. NO WORK TO BE CONCEALED UNLESS APPROVED AND SIGNED OFF BY INSPECTOR.
- 6. CONTRACTOR SHALL COMPLY WITH ALL APPLICABLE OSHA, CAL-OSHA. AND LOCAL SAFETY REGULATIONS, CONTRACTOR IS RESPONSIBLE FOR ALL JOB SITE SAFETY & SECURITY FOR ALL PERSONS ON JOB SITE. THIS INCLUDES SUBCONTRACTORS, INDEPENDENT CONTRACTORS, PROFESSIONALS, AND LAY PERSONS.
- 7. ALL MATERIALS TO COMPLY WITH THE APPLICABLE ICBO/2010 CSBC STANDARDS.
- 8. ALL EXTERIOR FASTENERS SHALL BE HOT DIPPED GALVANIZED IN ACCORDANCE WITH 200 CSBC STANDARD 25-17 AND PROJECT SPECIFICATIONS.
- CONTRACTOR TO PROVIDE TO OWNER OR THEIR AGENT A CONSTRUCTION PLAN SHOWING TRAILER, DEBRIS BOX, TOILETS, PARKING, AND MATERIAL STORAGE LOCATION ON SITE. FOR APPROVAL PRIOR TO START OF CONSTRUCTION.
- 10. CONTRACTOR SHALL CONFORM TO THE CITY GUIDELINES FOR HOURS OF CONSECUTION IN A RESIDENTIAL AREA: MON - FRI 7:00 AM TO 6:00 PM, SAT 9:00 AM TO 5:00 PM, NO WORK ON SUNDAYS/HOLIDAYS
- 11. CONTRACTOR TO PRESENT ALL WARRANTIES TO PROPERTY OWNERS AT END OF PROJECT.
- 12. CONTRACTOR TO PROVIDE UNCONDITIONAL LIEN RELEASES FROM ALL SUBCONTRACTORS AND SUPPLIERS PRIOR TO ALL PAYMENTS.
- 13. CONTRACTOR TO PROVIDE CERTIFICATE OF INSURANCE WITH OWNER AND ENGINEER OF RECORD AS NAMED ADDITIONAL INSURED FOR SELF AND ALL SUBCONTRACTORS.
- 14. PROVIDE TEMPORARY 6' HIGH SECURITY & PRIVACY FENCE AROUND SITE DURING CONSTRUCTION.
- 15. JOB SITE SHALL BE BROOM SWEPT, ORGANIZED, AND SECURED AT THE END OF EACH DAY. TOOLS & MATERIALS SHALL BE STORED & SECURED IN THEIR DESIGNATED LOCATIONS WITHIN SECURITY & PRIVACY FENCING. DEBRIS SHALL BE PLACED IN DEBRIS BOZ OR RECYCLED AS REQUIRED BY CITY, COUNTY, STATE, & FEDERAL REGULATIONS.
- 16. CONTRACTOR IS RESPONSIBLE FOR JOB SITE SAFETY FOR ALL EMPLOYEES SUBCONTRACTORS, SUPPLIERS, INDEPENDENT CONTRACTORS, PROFESSIONALS, & PEDESTRIANS ON JOB SITE AT ALL TIMES.

# GENERAL NOTES & REQUIREMENTS (CONT'D):

- 17. CONTRACTOR SHALL MAINTAIN EGRESS AT ALL TIMES.
- 18. CONTRACTOR SHALL REPAIR OR REPLACE ALL FIRE RATED CONSTRUCTION.
- 19. CONTRACTOR SHALL REPAIR OR REPLACE ALL FIRE RATED PENETRATIONS.

# RETROFIT PROCEDURE:

- 1. TEST WALLS THAT WILL BE RETROFITTED FOR THE PRESENCE OF LEAD & ASBESTOS BY C.I.H.
- 2. DEMOLISH INDICATED WALL SURFACES FOLLOWING ABATEMENT PROCEDURES SPECIFIED BY C.I.H.
- 3. DISPOSE OF MATERIALS FOLLOWING PROCEDURES SPECIFIED BY C.I.H.
- 4. INSTALL NEW FOUNDATION ELEMENTS WHERE SPECIFIED.
- 5. INSTALL SHEAR PLYWOOD ON CRIPPLE WALLS WHERE INDICATED & VENTILATE PER DETAILS.
- 6. INSTALL SHEAR PLYWOOD/PRE-FABRICATED SHEAR PANELS/MOMENT FRAMES & HOLDOWNS ON GROUND LEVEL WALLS WHERE INDICATED.
- 7. REPAIR WATERPROOFING & STUCCO/SIDING. MATCH (E) FINISH.
- 8. INSTALL 5/8" TYPE-X GWB ON INTERIOR WALL SURFACES WHERE INDICATED, FIRE TAPE. FLOAT & TEXTURE TO MATCH (E) SURFACES.
- 9. PAINT TO MATCH (E) COLORS.

# PRIORITY OF DOCUMENTS:

- 1. PRIORITY OF DOCUMENTS:
  - A. SIGNED CHANGE ORDERS AND ADDENDUM PREVAIL OVER..
  - B. CONTRACTS PREVAIL OVER...
  - C. WRITTEN SPECIFICATIONS, INCLUDING STANDARDS PRODUCT INSTALLATION & USE GUIDES, CODES, AND REGULATIONS, WHICH PREVAIL OVER...
  - D. INDUSTRY STANDARDS, CODES, AND GOVERNMENT REGULATIONS,
  - E. DRAWN PLANS.
- 2. WHEN A CONFLICT OR MULTIPLE REQUIREMENTS OCCUR, THE MOST RESTRICTIVE INTERPRETATION THAT PRODUCES THE HIGHEST QUALITY WORKMANSHIP CONSIDERING ALL REQUIREMENTS SHALL PREVAIL.
- 3. CODES, STANDARDS, AND REGULATIONS SHALL BE THE MOST RECENT VERSION IN FORCE AT THE TIME OF CONSTRUCTION.
- 4. ENGINEER OF RECORD SHALL BE THE FINAL ARBITEUR IN THE INTERPRETATION OF CONTRACT AND CONSTRUCTION DOCUMENTS.

# **WARNINGS:**

- 1. SITE CONDITIONS MIGHT VARY FROM PLANS, CONTRACTOR SHALL VERIFY ALL DIMENSIONS. WINDOW SIZES, PIPE LOCATIONS, PIPE SIZE, ETC. IN FIELD. CONTRACTOR SHALL CONFIRM DIMENSIONS PRIOR TO THE START OF CONSTRUCTION & AFTER DEMOLITION AND INFORM THE ENGINEER OF RECORD OF ALL VARIANCES.
- 2. PLANS ARE REPRESENTATIONAL AND ARE NOT EXACT REPLICATIONS OF EXISTING CONDITIONS. CONTRACTOR SHALL VERIFY ALL ASSUMED CONDITIONS AND DETAILS FOR ACTUAL FIELD CONSTRUCTION.
- 3. LOCATE (E) UTILITIES PRIOR TO ALL EXCAVATIONS.
- 4 EXCAVATE TO REQ'D DEPTH & NO FURTHER. DO NOT DISTURB SOIL BENEATH NEW
- 5. DO NOT ALLOW EXCAVATED SOIL TO DRY OR GET WET. ANY CHANGE IN MOISTURE CONTENT OF SUPPORTING SOIL SHALL BE REMEDIED BY SCARIFACATION TO A DEPTH OF 12" AND COMPACTION OF 95% OF OPTIMUM PER ASTM STANDARDS
- 6. OWNER SHOULD SEAL ALL JOINTS, CRACKS, & PENETRATIONS IN WALL ANNUALLY PRIOR TO RAINY

# PROJECT SUBMITTALS & REQUESTS FOR **INFORMATIONS:**

- INFORMATION CONTAINED IN THESE GENERAL NOTES & CONSTRUCTION NOTES MIGHT BE AMENDED BY INFORMATION IN CONTRACTORS SUBMITTALS AND BY ENGINEER OF RECORD'S RESPONSES TO REQUESTS FOR INFORMATION.
- 2. CONTRACTOR SHALL DIRECT ALL REQUESTS FOR INFORMATION TO ENGINEER OF
- CONTRACTOR SHALL SUBMIT PRODUCT DATA SHEETS AND SPECIFICATIONS TO ENGINEER OF RECORD FOR APPROVAL PRIOR TO CONSTRUCTION FOR ALL PRODUCTS USED ON THE PROJECT.
- 4. CONTRACTOR SHALL PROVIDE BOUND COPIES OF ALL WARRANTIES, MANUALS, & INSTRUCTIONS, ETC. TO E.O.R. AT END OF PROJECT.
- 5. CONTRACTOR SHALL HIRE ENGINEER OF RECORD FOR THESE SERVICES UNLESS HIRED BY OWNER.

# **CONCRETE & REINFORCING STEEL:**

- 1. ALL CONCRETE SHALL BE F'C=2500 PSI MIN. USE 6-SACK MIX OF TYPE IIA CEMENT. MAX W/C RATIO OF 0.5 MAX AGGREGATE SIZE 3/4".
- 2. SANDBLAST OR ROUGHEN & CLEAN EXISTING CONCRETE SURFACES WHEN CASTING NEW CONCRETE AGAINST EXISTING CONCRETE.
- 3. APPLY WELD-CRETE BONDING AGENT (OR EQUIVALENT) TO EXISTING CONCRETE SURFACES.
- 4. ALL REINFORCING STEEL SHALL HAVE FY=60 KSI MIN.
- LEVELING/TOPPING COMPOUNDS SHALL BE QUICKCRETE SAND TOPPING MAX.
- FLATWORK REPAIRS SHALL BE PERFORMED WITH SHRINKAGE COMPENSATING TYPE 1 CEMENT.
- 7. ALL CONCRETE WORK SHALL COMPLY WITH THE CURRENT ACI MANUAL OF STANDARD
- 8. ALLREINFORCING STEEL WORK SHALL COMPLY WITH THE CURRENT CRSI MANUAL OF STANDARD PRACTICE.

**REVISIONS DATE** 

### W. CHARLES PERRY & **ASSOCIATES**

231 W. 41ST AVENUE SAN MATEO, CA 94403 650-638-9546



**DRAWINGS ARE** HALF SCALE **AND NOT FOR CONSTRUCTION** WHEN SHOWN **ON 11X17 OR NOT WET SIGNED AND DATED** 

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DATE:

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5-19-14 DRAWN BY:

# **FASTENERS:**

- 1. ALL FASTENERS TO BE HOT DIPPED GALVANIZED.
- 2. ALL HOT DIPPED GALVANIZED FASTENERS TO MEET STANDARD ASTM-A153.
- 3. ALL EXTERIOR FASTENERS SHALL BE HOT DIPPED GALVANIZED IN ACCORDANCE WITH 2010 CSBC STANDARD 25-17 AND PROJECT SPECIFICATIONS.

# **FLASHING:**

- 1. ALL FLASHING TO BE HOT DIPPED GALVANIZED 24 GAUGE GSM OR BETTER.
- 2. HEM ALL CUT EXPOSED EDGES.
- 3. USE BONDERIZED GSM OR PICKLE GSM PRIOR TO PRIMING.
- 4. PRIME GSM PRIOR TO INSTALLATION.
- 5. SEAL ALL LAPPED HORIZONTAL GSM JOINTS WITH MOISTOP SEALANT.
- 6. SOLDER ALL CORNERS & EDGE JOISTS.
- 7. SLOPE ALL Z FLASHING & HEAD FLASHING TO DRAIN.
- 8. ALL SHEET METAL WORK SHALL CONFORM W/ SMACNA ARCHITECTURAL SHEET METAL MANUAL.

# **DECAY RESISTANCE:**

1. TREAT ALL CUT ENDS AND SIDES OF PTDF WITH DECAY RESISTANT SURFACE TREATMENT SUCH AS SODIUM OCTOBORATE OR EQUIVALENT PRIOR TO FURTHER PAINTING OR STAINING.

# **MINOR DECAY REPAIRS:**

- 1. REMOVE DECAYED WOOD.
- 2. SATURATE DAMAGED SURFACE WITH "CPES" AND ALLOW TO CURE PER MANUAL INSTRUCTIONS.
- 3. FILL VOID WITH FILLER EPOXY AND ALLOW TO CURE PER MANUFACTURERS INSTRUCTIONS. COLOR TO MATCH EXISTING WOOD WITH "BROWN EPOXY COLORING AGENT."
- 4. SHAPE EPOXY FILLER TO MATCH EXISTING SURFACE.

IOTE: ALL PRODUCTS AVAILABLE FROM HTTP://WWW.ROTDOCTOR.COM.
EQUIVALENT PRODUCTS MAY BE SUBSTITUTED UPON REVIEW AND APPROVAL
BY ENGINEER OF RECORD.

# **PAINTING & STAINING:**

- 1. PAINT REPAIRED PORTIONS OF BUILDING. THIS INCLUDES TRIM, FLASHING, DOWN SPOUTS, & DOORS SHALL BE PAINTED OR STAINED AS SPECIFIED BELOW. PAINT TO ARCHITECTURAL LIMITS.
- 2. PAINT PER PAINTING AND DECORATION CONTRACTORS OF AMERICA HANDBOOK, AND PAINT MFG.'S SPECIFICATIONS. SEMI-GLOSS ENAMEL AT KITCHEN AND BATH, FLAT LATEX ELSEWHERE INSIDE AND OUTSIDE. GARAGE AND SHOP SPACES ARE TO BE PAINTED. PAINT ALL FLASHING, GUTTERS, AND LEADERS. PAINT SHALL BE PRIMER & 2 TOP COAT UNLESS OTHERWISE SPECIFIED BY PAINT MANUFACTURER. INTERIOR WOODWORK, TRIM DOORS AND WINDOWS SHALL BE PAINTED WITH SEMI-GLOSS ENAMEL. PAINT GRADE AND COLOR PER OWNER'S SPECIFICATIONS AND APPROVAL. USE DUN EDWARDS OR EQUIVALENT.
- 3. PRIME.
- 4. FILL ALL GAPS, CRACKS, VOIDS, & UNEVEN SURFACES WITH ACRYLIC PUTTY/CAULKING.
- 5. SEAL ALL GAPS AT DOORS, WINDOW, & PENETRATIONS WITH ACRYLIC SEALANT.
- 6. TOP COAT 2 TIMES. PAINT SHOULD BE SPECIFICALLY FORMULATED FOR INTENDED SURFACE FINISH.
- 7. ALLOW GUARDRAILS AND POSTS TO SEASON FOR 8 WEEKS.
- 8. STAIN GUARDRAILS AND POSTS WITH DUNN-EDWARDS SEMI-SOLID EXTERIOR STAIN OR EQUIVALENT. PUT FUNGICIDE IN STAIN PRIOR TO APPLICATION.

# **TECHNICAL NOTES:**

### A. GENERAL

- 1. All existing concrete and wood material which will be port of the strengthening work shall be in sound condition and free from defects which would substantially reduce the capacity of the material. Any substandard material shall be repaired or replaced to meet minimum building code requirements. New foundations shall meet current Building Code requirements.
- 2. All metal connectors and hardware shall meet on approved standard for its intended use and be installed per manufacturer's instructions, and in accordance with the requirements of these standards. Alternate details may be approved by the building official provided detailed information and calculations are submitted and approved.
- 3. All existing under floor ventilation shall be maintained.
- 4. Due to the corrosive nature of new pressure treated wood which con cause premature failure of the metal hardware, fasteners in new pressure treated wood shall be hot dipped galvanized fasteners {meeting ASTM A 153) and connectors {ASTM A 653 class G185 sheet), or better.
- 5. LEGEND:
- (E) = Existing construction; (N) = New construction 4/S1 = Refer to detail 4 on sheet S1 NTS = Not to scale; Min = Minimum FFC = Floor Framing Clip

### **B. MUDSILL CONNECTIONS**

- 1. New bolts or UFP 1 0 anchors required by reinforcement schedule 4/S1 shall be installed within plywood braced panel s. See detail 2/52.
- 2. Where on existing continuous rim joist, end joist, or solid blocking between joists, does not exist above the perimeter cripple wall or mud sill, new blocking and/or supplemental connections shall be provided ond subject to approval by the building official.
- 3. All new mud sill bolts shall have a 3"X3"X1/4" plate washer installed between the mud sill (or blocking) and the nut.
- 4. New bolts shall be 1-1/2" inches minimum from the edges of the mud sill and 6" from the ends.
- 5. Existing anchor bolts are generally not reliable and should not be considered as meeting the requirements of this plan set.
- 6. New bolts or anchors within new braced panels shall be placed as follows:
- a) one bolt or anchor at each end of the braced bay
- b) additional bolts or anchors at 32" on center or less.
- c) additional foundation bolts or anchors as required by the schedule detail 4/S1.
- 7. New mudsill plates shall be pressure-treated douglas- fir or foundation-grade redwood.
- 8. New steel bolts shall conform to ASTM A307. Adhesive or expansion type anchors shall be installed per manufacturer's instructions. Third party special inspection is not required. Expansion bolts shall not be used when the installation causes cracking of the foundation wall at the location of the bolt. The use of "adhesive type" anchors is strongly encouraged.
- 9. Provide new mudsill bolts or anchors outside of braced panels at 6'-0" on center or less.

# C. FLOOR TO CRIPPLE WALL/MUDSILL CONNECTION

- 1. See "Reinforcement Schedule" 4/S1 ond detail 5/S2 for required connection.
- 2. Increase length of nails 1/2" when attaching floor framing clips through plywood.
- 3. If splices in double top plates do not have a minimum 48" lap, provide a new minimum 4' strap. See detail 6A/S2.
- 4. Existing single top plates shall reinforced with a 16ga x 48" metal strap. See detail 6B/S2.
- 5. Where plate straps occur within a braced panel, the strop shall be placed over the plywood and the plywood nails omitted where the strap in installed.

### D. PLYWOOD BRACED PANEL INSTALLATION

- 1. See 4/S1 "Rei11forcement Schedule" for the required length of new plywood panel bracing along each wall line. See "Sample Foundction Plan" for the definition of a "wall line" and an example of plywood panel layout.
- 2. Install plywood braced panels of each end of each wall line and space additional panels, as needed, along each wall line.
- 3. Plywood braced panels closest to the ends of wall lines shall be located as near to the ends os possible. Panels may be located away from the ends of a wall line when existing obstructions or limited clearance necessitates such relocation.
- 4. Plywood braced !panels should be nearly equal in length and should be nearly equal in spacing along the length of the wall where possible.
- 5. The length of each individual panel must be twice the height of the cripple wall being braced, but never less than 48 inches in length.
- 6. The perimeter of oil new plywood braced panel shall be nailed to existing cripple wall studs, top plate(s) and the mudsill at 4" on center. Attach plywood to intermediate cripple wall studs at a maximum of 12" on center.
- 7. Nails shall be 8d common x 2-1/2" long with a minimum shank diameter of .131 inches (.131 x 2-1/2"). .131 x 2-1/8" nails may be used for installations using nail guns.
- 8. Plywood braced panel shall be 5-PLY, 15/32" exterior grade CDX S1 (3-PLY 15/32" is not acceptable).
- 9. Maintain a minimum edge distance 3/8", from center of nail to any plywood edge.
- 10. Do not overdrive, countersink, or otherwise damage the "outermost ply" when installing nails.
- 11. Do not space nails closer than 3-1/2" in plywood braced panels.
- 12. Nails must be firmly embedded in framing behind plywood without causing splitting. See detail 4A/S2 for double stud at plywood joints.

# STUCCO:

- 1. CONTRACTOR TO PARTIALLY REMOVE STUCCO AND BUILDING PAPER WHERE REQUIRED. WHERE WATER DAMAGED SUBSTRAIT IS ENCOUNTERED, CONTRACTOR TO REMOVE SECTION OF BOARD, AND CHECK FOR ADDITIONAL WATER DAMAGE. IF DAMAGED WOOD IS ENCOUNTERED CONTRACTOR TO NOTIFY E.O.R. PRIOR TO REMOVING ADDITIONAL GYPSUM BOARD & STARTING ANY REPAIRS.
- 2. CONTRACTOR TO INSTALL 2 LAYERS OF 'JUMBO TEX 60' PAPER, LAPPED TO DRAIN, AT ALL (N) AND REPAIRED LOCATIONS.
- 3. INSTALL GALVANIZED STUCCO LATH, SCREEDS, & EXPANSION JOINTS IN ACCORDANCE W/ASTM C1063-99 AND MFG.'S RECOMMENDATIONS.
- 4. PROVIDE 7/8" NEW STUCCO WHERE REQ'D. TO MATCH EXISTING FINISH. APPLY STUCCO AS FOLLOWS:
- A. MIN. 3 COATS PER ASTM C 926-98A & NWCB STUCCO & PLASTER RESOURCE GUIDE
- B. TEXTURED TO MATCH EXISTING STUCCO
- C. SCRATCH AND BROWN COATS SHOULD BE WET CURED FOR 7 DAYS MIN. ALLOWED TO HARDEN FOR 14 DAYS PER STUCCO ASSOCIATION RECOMMENDATIONS. BEFORE ANY SUBSEQUENT COATS ARE APPLIED. PATCH ALL CRACKS IN BROWN COAT PRIOR TO APPLYING FINISH COAT. THE FINISH COAT OF STUCCO SHOULD BE ALLOWED TO CURE FOR 28 DAYS PRIOR TO PAINTING.
- 5. FOR ADDITIONAL CURING GUIDELINES, CONTRACTOR TO FOLLOW NORTHWEST WALL AND CEILING BUREAU GUIDELINE & THE CBC WET CURE 7 DAYS MIN.
- 6. WHEN JOINING OLD STUCCO TO NEW, BREAK OLD STUCCO TO AN INTACT, UNEVEN EDGE. REMOVE ALL LOOSE OR CRACKED STUCCO. LEAVE 2 INCH MINIMUM WIRE LATH EXPOSED. LAP NEW BUILDING PAPER TO (E) BUILDING PAPER, 2" MIN. ON HORIZONTAL JOINTS & 6" MIN ON VERTICAL JOINTS. COAT ALL (E) SURFACES W/ WELDCRETE OR COMPATIBLE BONDING AGENT. APPLY SCRATCH AND BROWN COATS AND LEAVE ROOM FOR (N) FINISH COAT TO MATCH (E) FINISH COAT. BLEND (N) FINISH COAT INTO (E) FINISH COAT, BOND WITH WELDCRETE.
- 7. CONTRACTOR SHALL SUBMIT PRODUCT LITERATURE TO ENGINEER OF RECORD FOR REVIEW & APPROVAL PRIOR TO INSTALLATION.

# **REPAIR STUCCO:**

- 1. INSTALL NEW WEEP SCREED & COUNTER-FLASHING REGLET WHERE SHOWN & AS SHOWN
- 2. INSTALL NEW BUILDING PAPER & LATH; TIE OLD LATH TO NEW; LAP OLD LATH WITH NEW
- 3. INSTALL NEW 3-COAT STUCCO SYSTEM. MATCH EXISTING TEXTURE. BLEND NEW STUCCO TO OLD ACROSS JOINTS
- 4. INSTALL NEW COUNTER-FLASHING
- 5. PAINT NEW STUCCO & COUNTER-FLASHING TO MATCH EXISTING. BLEND NEW PAINT TO OLD.
- 6. INSTALL NEW COUNTER-FLASHING

# **SPECIAL INSPECTIONS:**

CONTRACTOR IS RESPONSIBLE FOR HIRING SPECIAL INSPECTORS. COLLECTING REPORTS, AND DISTRIBUTING COPIES OF REPORTS TO E.O.R., OWNER, & CITY OF SAN FRANCISCO, UNLESS HIRED BY OWNER

- 1. ANCHOR BOLT INSTALLATION
- 2. CONCRETE FORMWORK & REBAR PLACEMENT
- 3. EPOXY SETTING OF REBAR DOWELS

# **INSPECTIONS BY ENGINEER OF RECORD:**

ENGINEER OF RECORD SHALL BE HIRED BY CONTRACTOR TO PROVIDE THE REQUIRED STRUCTURAL OBSERVATIONS AND PERIODIC & FINAL REPORTS TO THE CITY OF SAN FRANCISCO DEVELOPMENT & ENVIRONMENTAL SERVICES DEPARTMENT, BUILDING & SAFETY, PER SAN FRANCISCO CITY ORDINANCE NO. 31-2007, SECTION 7-1220.1709

- 0. PRE-BID INSPECTION WITH CONTRACTOR & OWNER
- 1. AFTER DEMOLITION
- AFTER EXCAVATION, FORMWORK, & REBAR PLACEMENT
   DURING ANCHOR BOLT & HOLDOWN INSTALLATION
- 4. AFTER PLYWOOD SHEATHING /PRE-FABRICATED SHEAR PANEL/MOMENT FRAME
- 5. AFTER WALLBOARD INSTALLATION & TAPING AND FIREPROOFING6. AFTER PLASTERING & WATERPROOFING AND LATH INSTALLATION
- 7. AFTER SCRATCH & BROWN COAT STUCCO INSTALLATION
- 8. AFTER FINISH COAT INSTALLATION
  9. PUNCH-LIST INSPECTION
- 10. FINAL INSPECTION
- IU. FINAL INSPECTION
- A. WHERE NEW FOUNDATION ELEMENTS ARE REQUIRED

  1. AFTER EXCAVATION, FORMWORK & REBAR PLACEMENT

  2. EPOXY SETTING OF REBAR DOWELS
- B. WHERE FLATWORK IS INSTALLED TO IMPROVE DRAINAGE
  1. AFTER SURFACE PREPARATION & INSTALLATION OF SCREEDS
- 1. AFTER SURFACE PREPARATION & INSTALLATION OF SCREED 2. AFTER PLACEMENT & FINISHING OF (N) FLATWORK
- C. WHERE COLUMNS & POST BASES ARE REPAIRED1. AFTER DEMOLITION OF CONCRETE & DAMAGED PORTIONS OF POST BASES
  - 2. AFTER WELDING ON (N) POST BASES TO REMNANTS OF (E) POST BASES
    3. AFTER INSTALLATION OF (N) COLUMNS

    ENCINEED OF RECORD CHALL BE NOTIFIED TWO (2) BUSINESS DAYS IN ADVANCE OF A
- D. ENGINEER OF RECORD SHALL BE NOTIFIED TWO (2) BUSINESS DAYS IN ADVANCE OF ALL REQ'D INSPECTIONS. IF ENGINEER OF RECORD IS NOT NOTIFIED OF INSPECTIONS, OR DOES NOT PERFORM THEM, CONTRACTOR SHALL ACCEPT FULL LIABILITY FOR ALL LIABILITY.

NO. DATE

## W. CHARLES PERRY & ASSOCIATES

231 W. 41ST AVENUE SAN MATEO, CA 94403 650-638-9546



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DRAWINGS ARE
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AND NOT FOR
CONSTRUCTION
WHEN SHOWN
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NOT WET
SIGNED AND
DATED


Y SEISMIC RETROFIT

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eneral Notes

**DATE:** 5-19-14 **DRAWN BY:** DMH



REVISIONS
NO. DATE
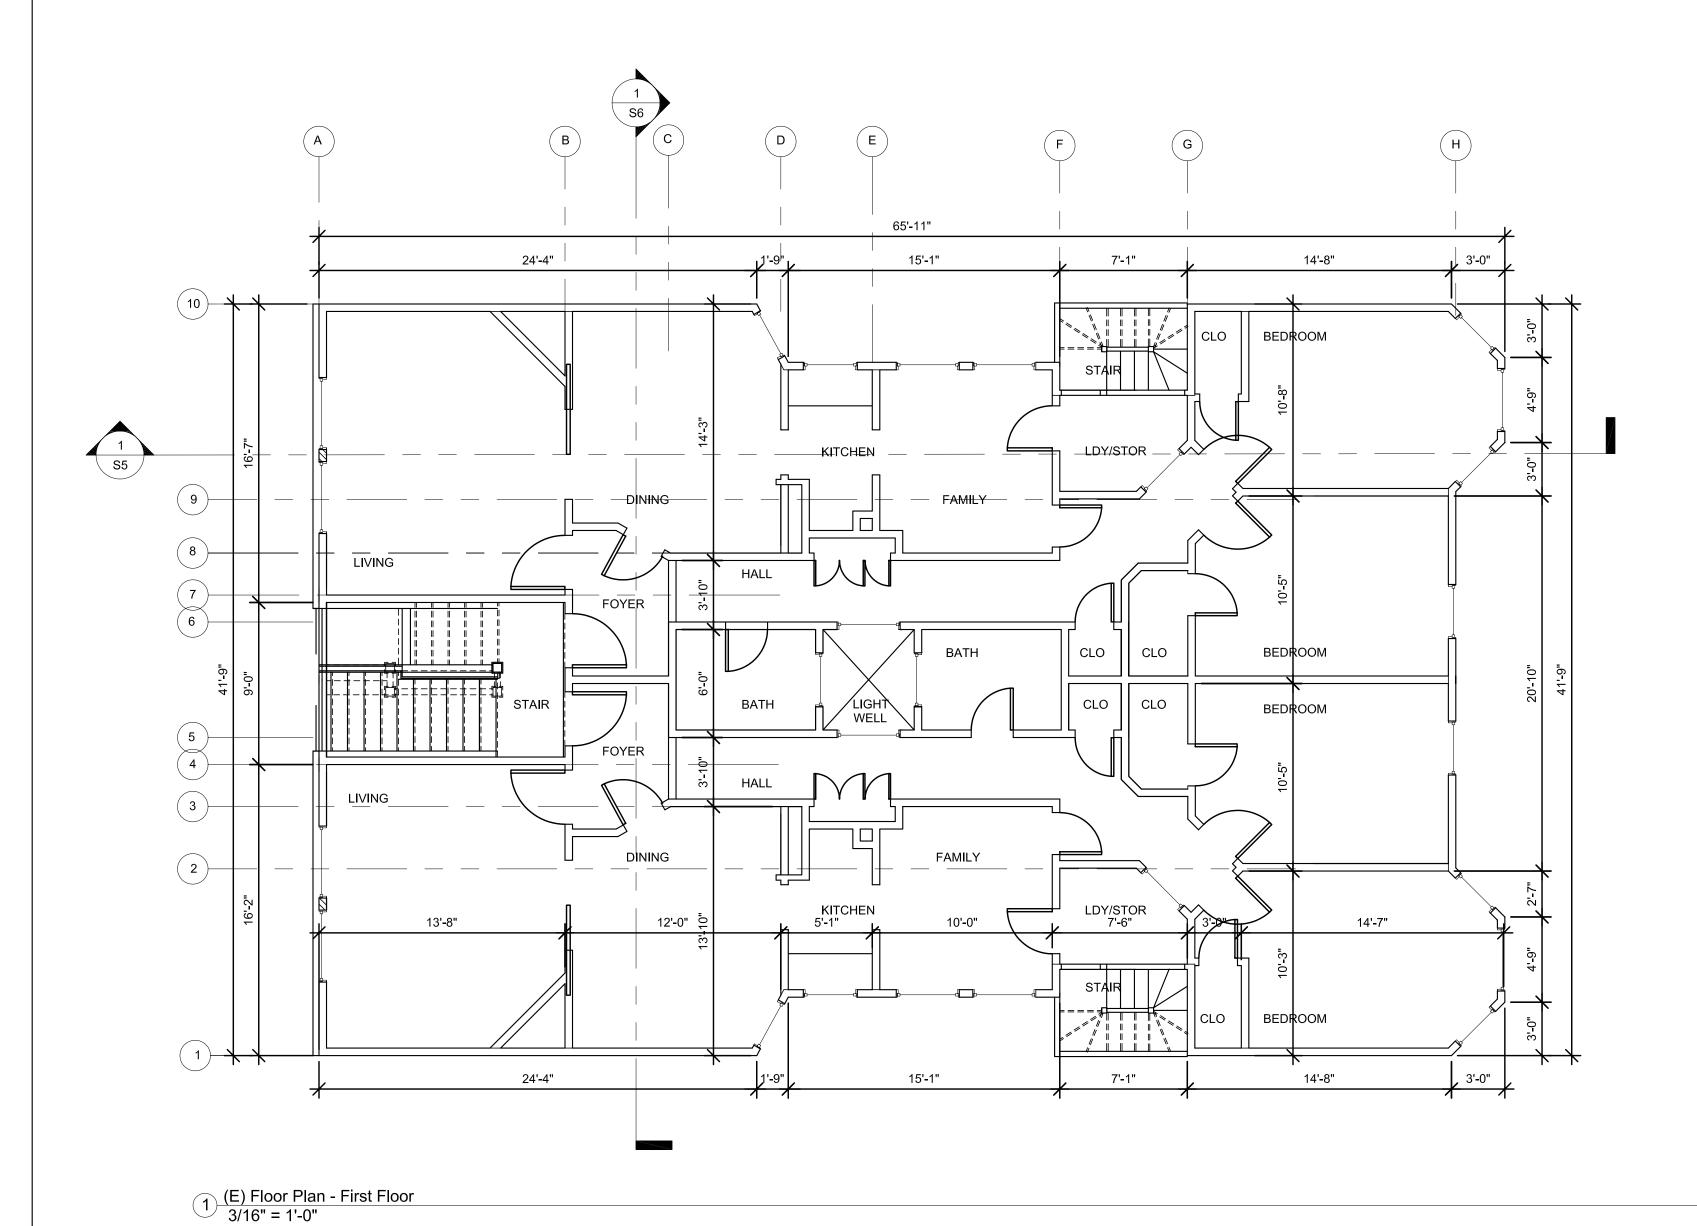
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ORY SEISMIC RETROFIT

Hoff Street

17 Hoff Street
San Francisco, CA 94


3/16" = 1'-0"

 DATE:
 5-23-14

 DRAWN BY:
 DMH

JOB #:

A

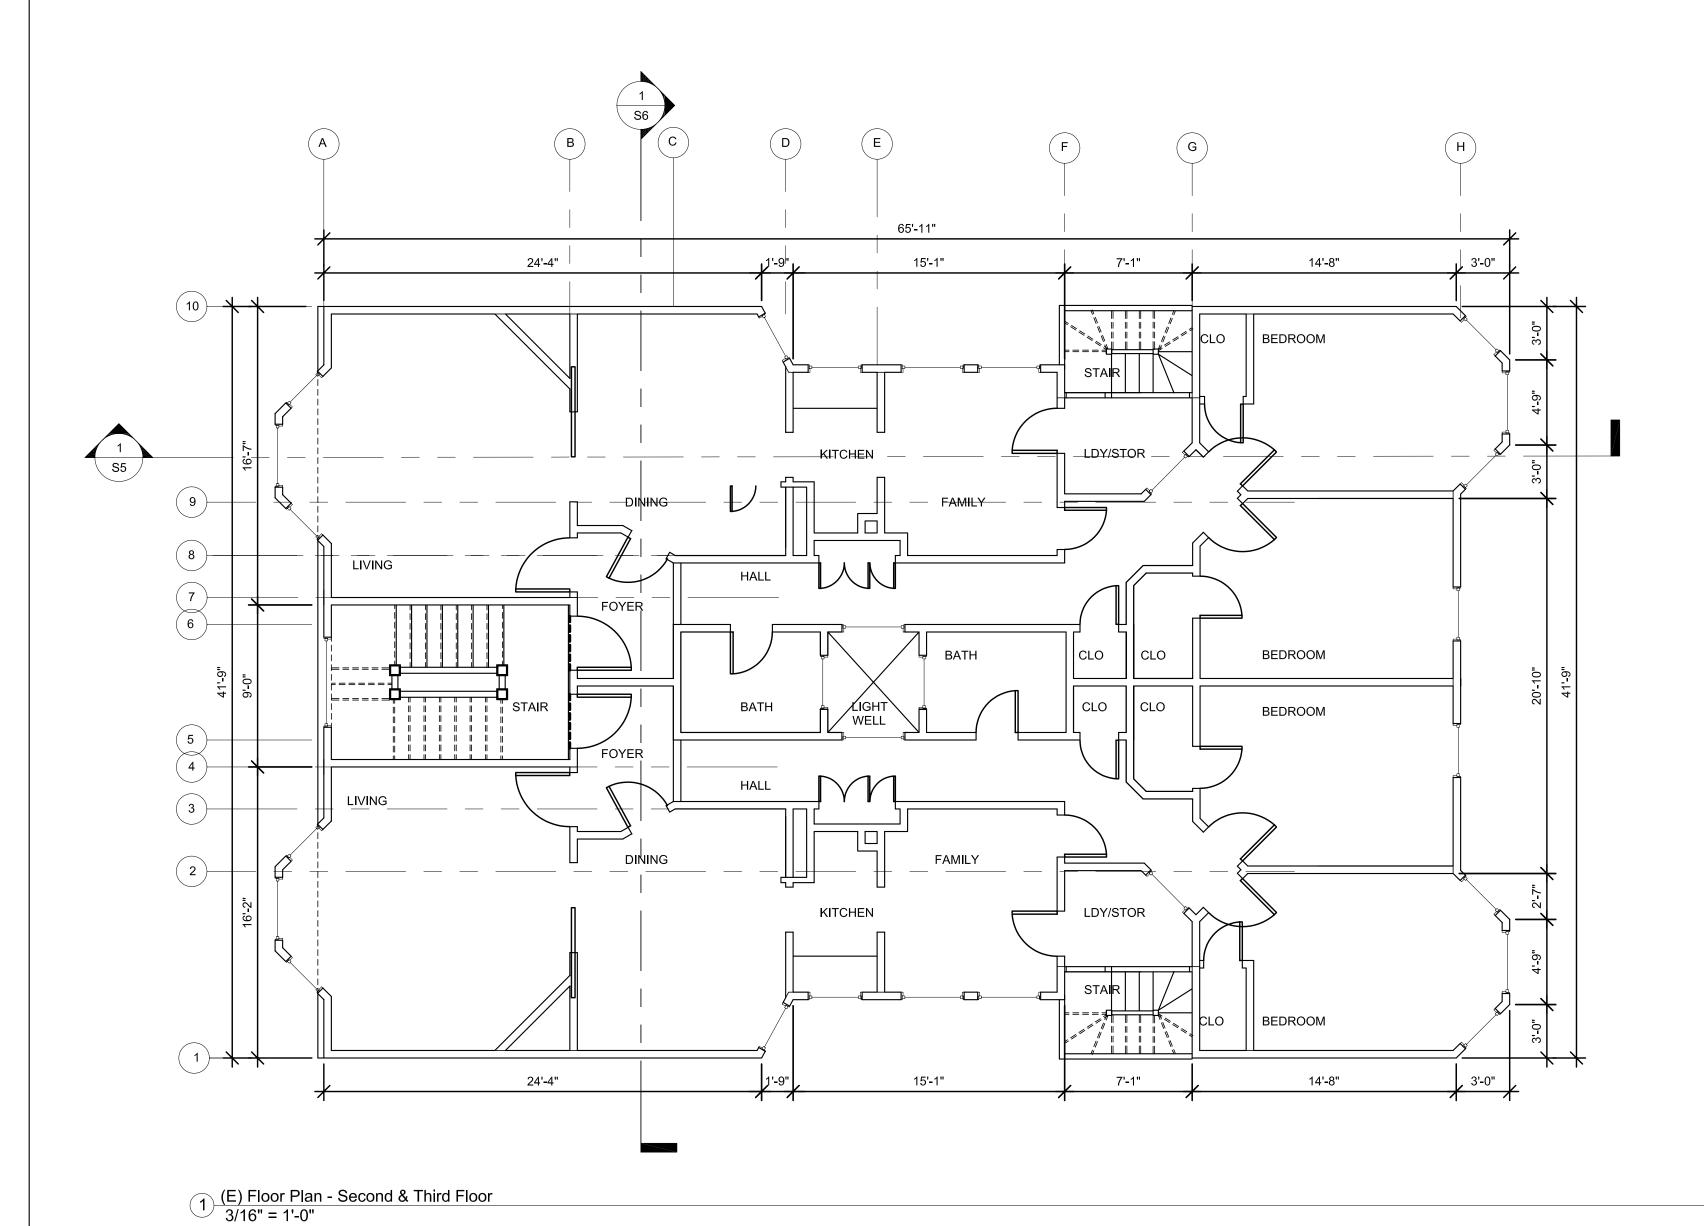

**REVISIONS** NO. DATE

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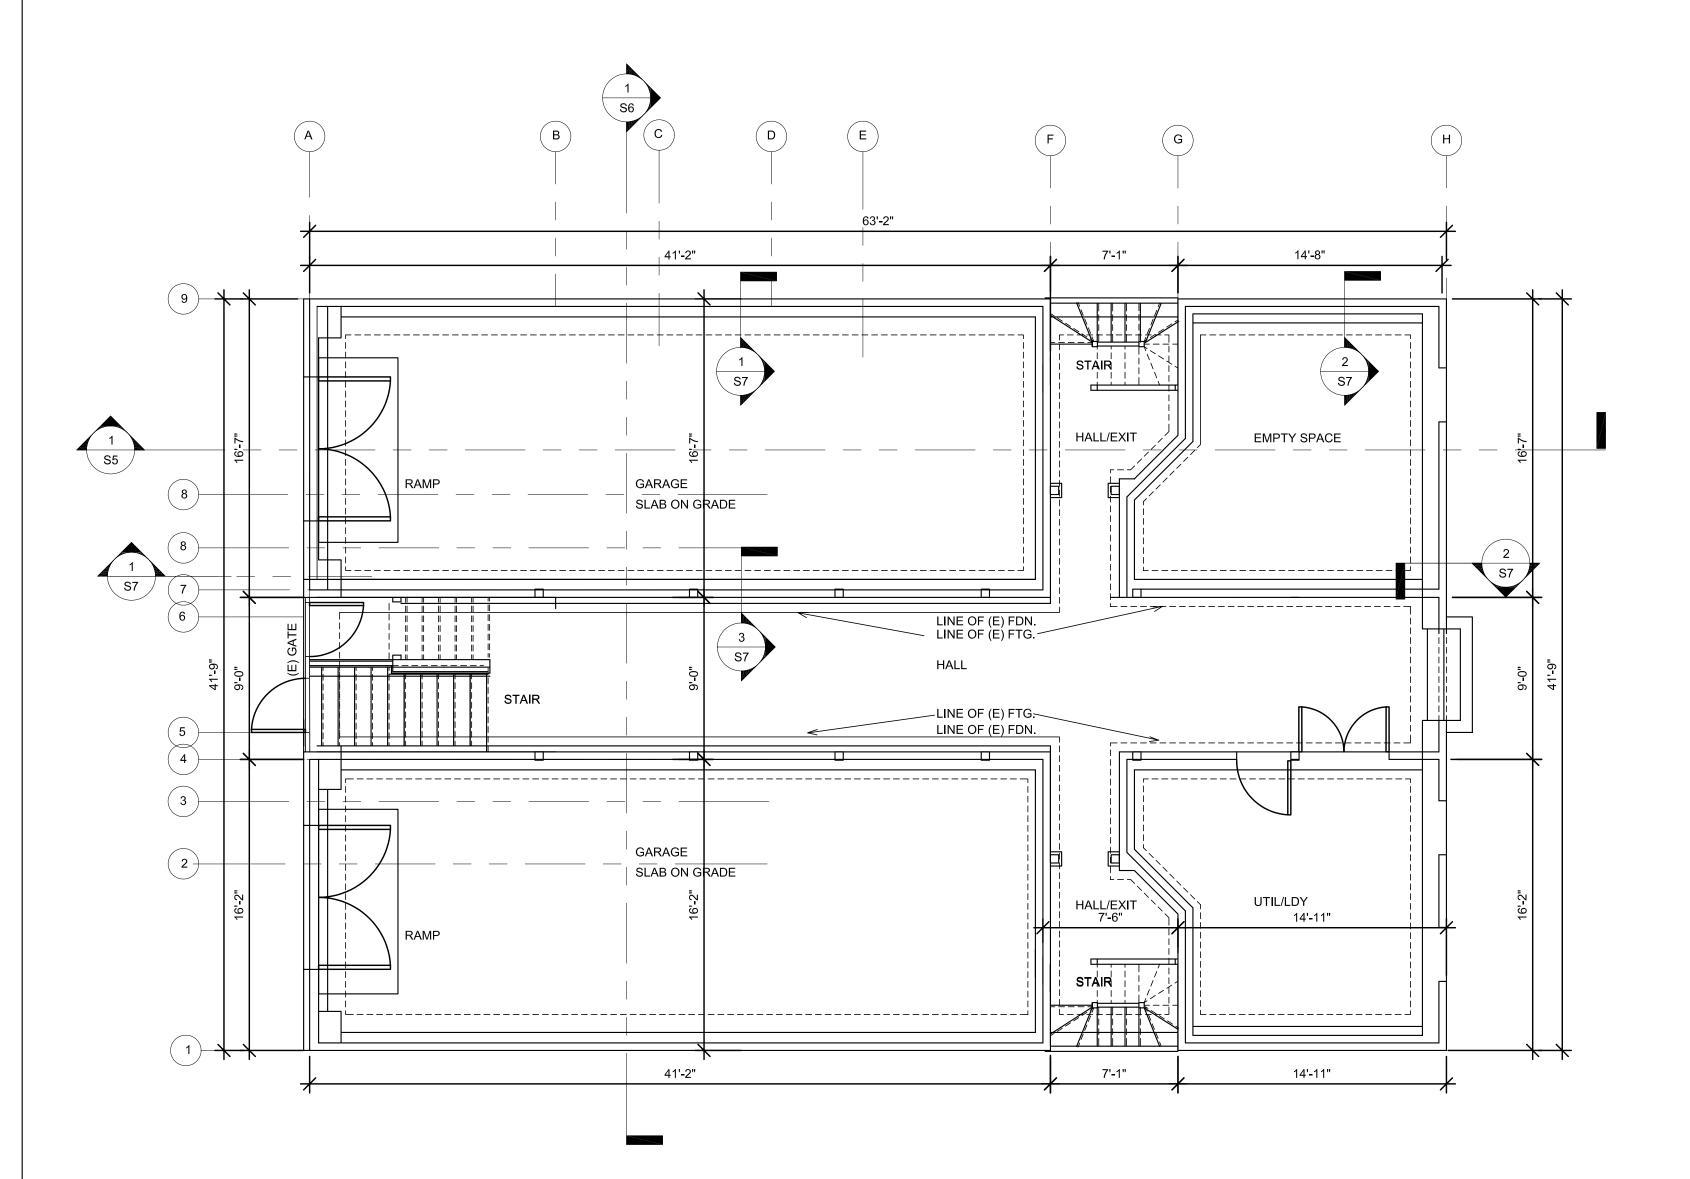



DRAWINGS ARE HALF SCALE AND NOT FOR CONSTRUCTION WHEN SHOWN **ON 11X17 OR NOT WET** SIGNED AND **DATED** 

17 Hc Francis

(E) Floor Plan - Second Third Floors 3/16"

DATE: 5-23-14 DRAWN BY:



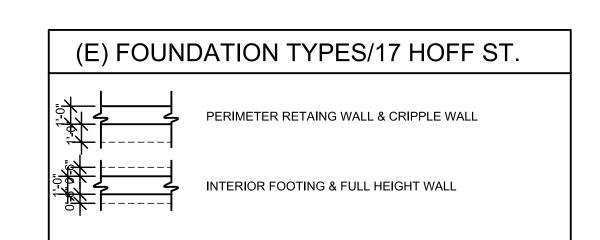


(E) Foundation Plan 3/16" = 1'-0"

REVISIONS					
NO.	DATE				

# W. CHARLES PERRY & ASSOCIATES

231 W. 41ST AVENUE SAN MATEO, CA 94403 650-638-9546

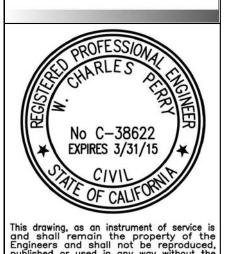

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off Street

n Plan SOFT-S1


(E) Foundation Pla

 DATE:
 5-23-14


 DRAWN BY:
 DMH

JOB #:

S1

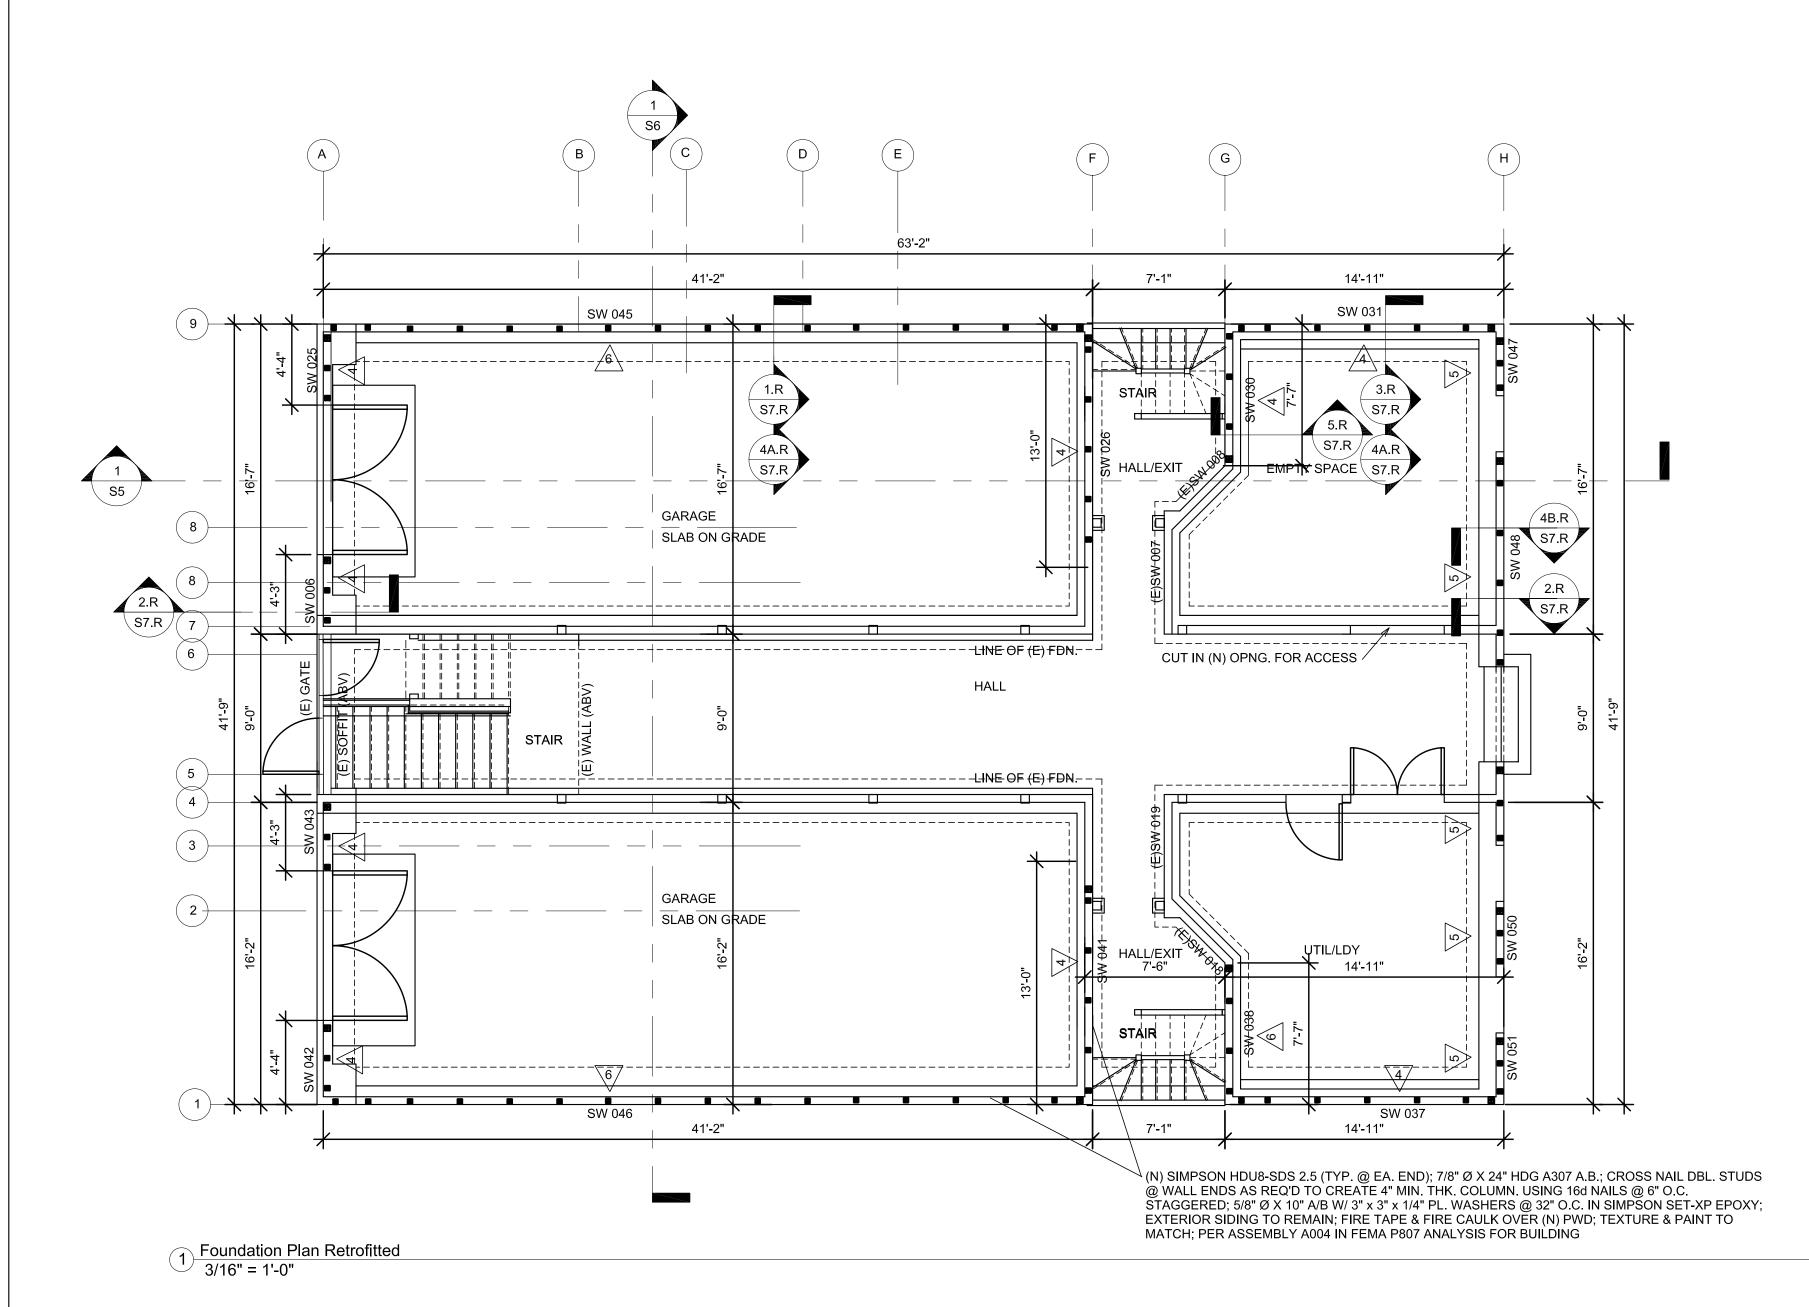


			WALL TYPES		
ASS'Y#	SH. WALL#	TYPE	PWD & NAILS	HOLDOWNS	STRAP TO (E/N) HEADER
4	SWØØ6 SWØ25 SWØ26 SWØ30 SWØ31 SWØ37 SWØ41 SWØ42 SWØ43	GARAGE EXT-INT STRONG	15/32" STRUCT 1 PWD 10d COMMON NAILS @4" O.C.	SIMPSON HDU8-SDS 2.5 X 6" END POSTS 7/8"Ø X 24" A307 ALL THREAD ROD SET IN SIMPSON SET-XP EPOXY	MST 27 MST 27 MST 27 MST 27 MST 27 MST 27 MST 27
	SWØ47 SWØ48 SWØ49 SWØ50 SWØ51	UTIL/STOR. INT-EXT WEAK	15/32" STRUCT 1 PWD 8d COMMON NAILS @ 6" O.C.	SIMPSON HDU8-SDS 2.5 X 6" END POSTS 7/8"Ø X 24" A307 ALL THREAD ROD SET IN SIMPSON SET-XP EPOXY	MST 27 MST 27 MST 27 MST 27 MST 27
6	SWØ38 SWØ45 SWØ46	GARAGE & UTIL. INT-EXT MEDIUM	15/32" STRUCT 1 PWD 10d COMMON NAILS @ 6" O.C.	SIMPSON HDU8-SDS 2.5 X 6" END POSTS 7/8"Ø X 24" A307 ALL THREAD ROD SET IN SIMPSON SET-XP EPOXY	MST 27
		1	PHASE II WORK	1	
ASS'Y#	SH. WALL#	TYPE	PWD & NAILS	HOLDOWNS	STRAP TO (E/N) HEADER
<u>^</u>	SWØØ1 SWØØ4 SWØØ5 SWØØ7 SWØ09 SWØ10 SWØ11 SWØ15 SWØ16 SWØ19 SWØ20 SWØ20 SWØ23 SWØ25 SWØ29	APARTMENT EXT-INT	15/32" STRUCT 1 PWD 10d COMMON NAILS @ 4" O.C.	NONE	NONE
8	SWØ25 SWØ29 SWØ31 SWØ45 SWØ47 SWØ51 SWØ57 SWØ58 SWØ51	APARTMENT INT-INT	15/32" STRUCT 1 PWD 10d COMMON NAILS @ 4" O.C.	NONE	NONE

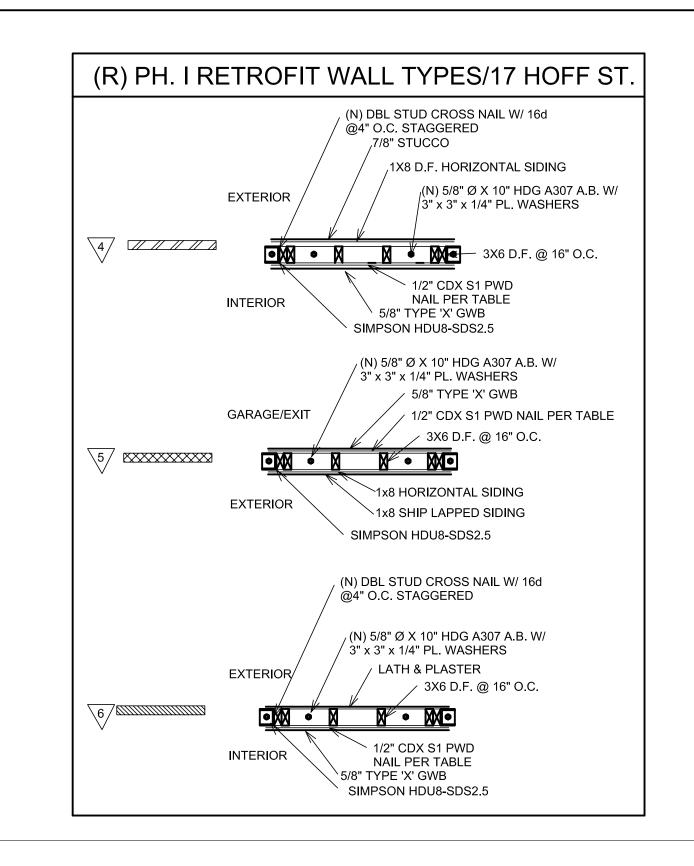

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17 Hoff


oundation Plan Retrofitted 3/16" = 1'-0"


DATE: 5-23-14

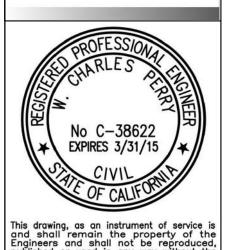DRAWN BY: DMH

JOB #:

S1 R

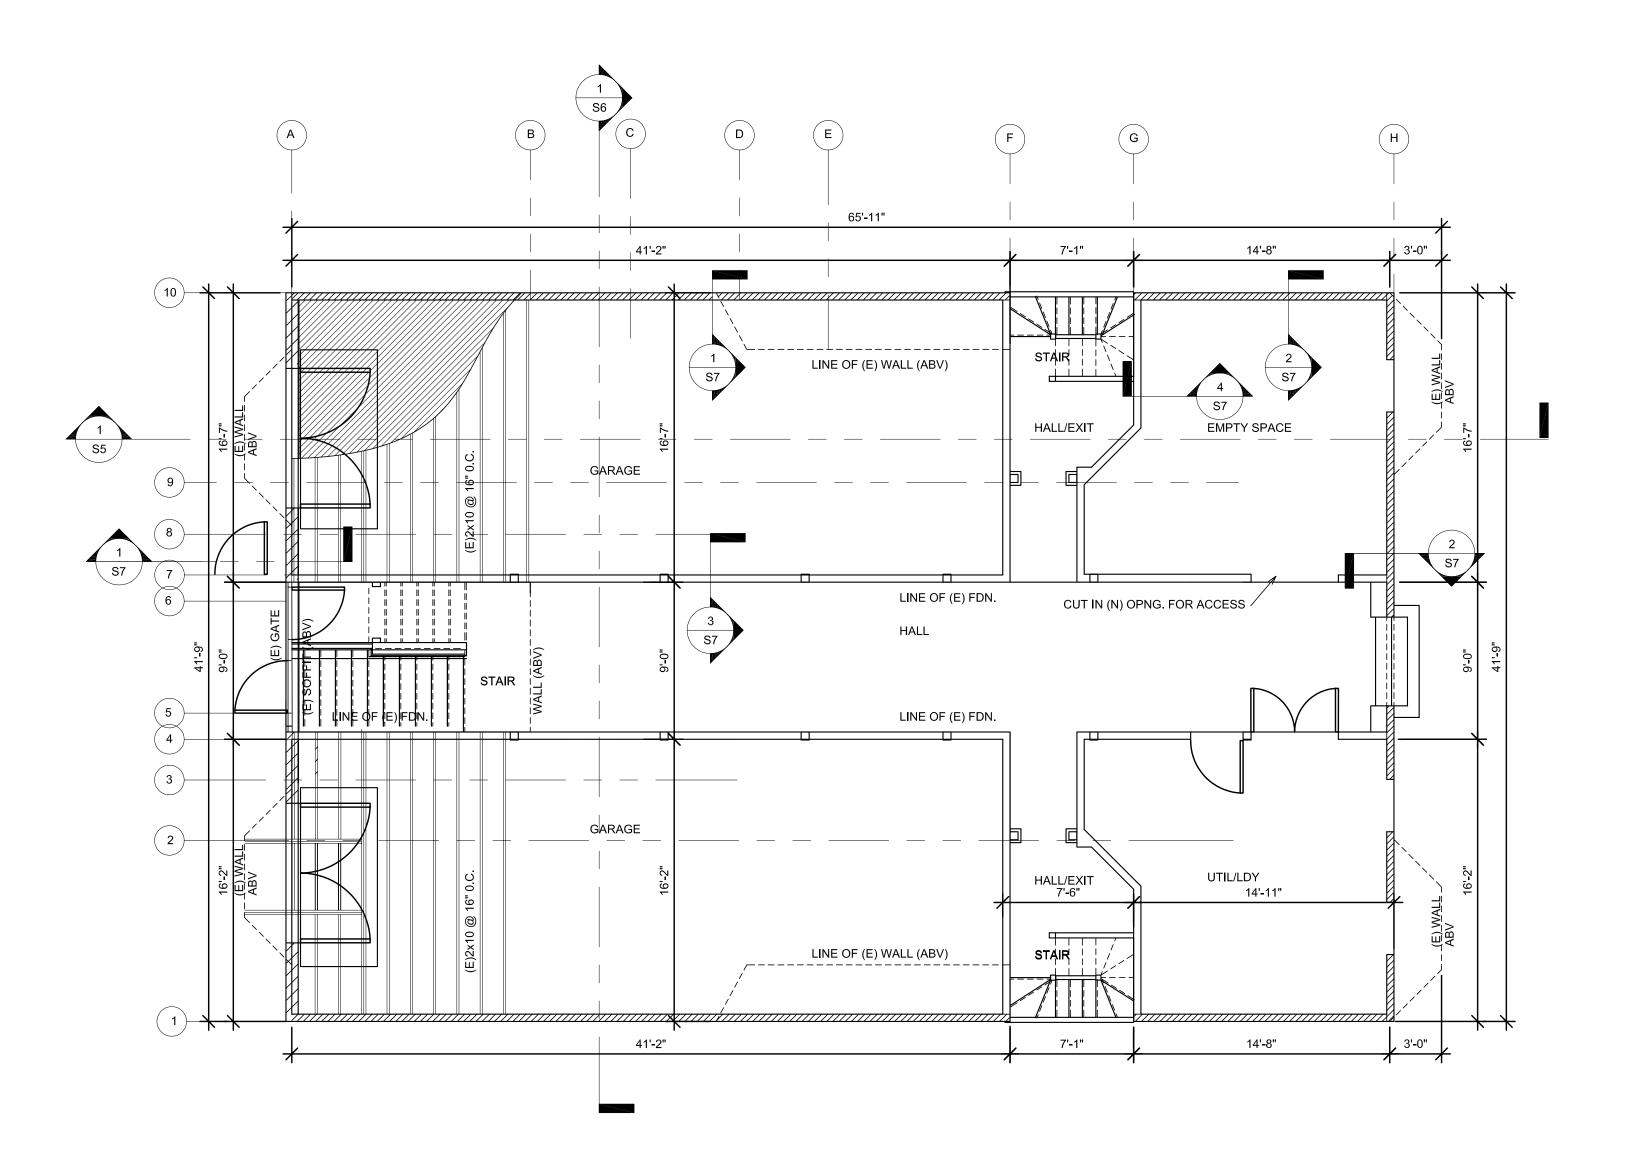

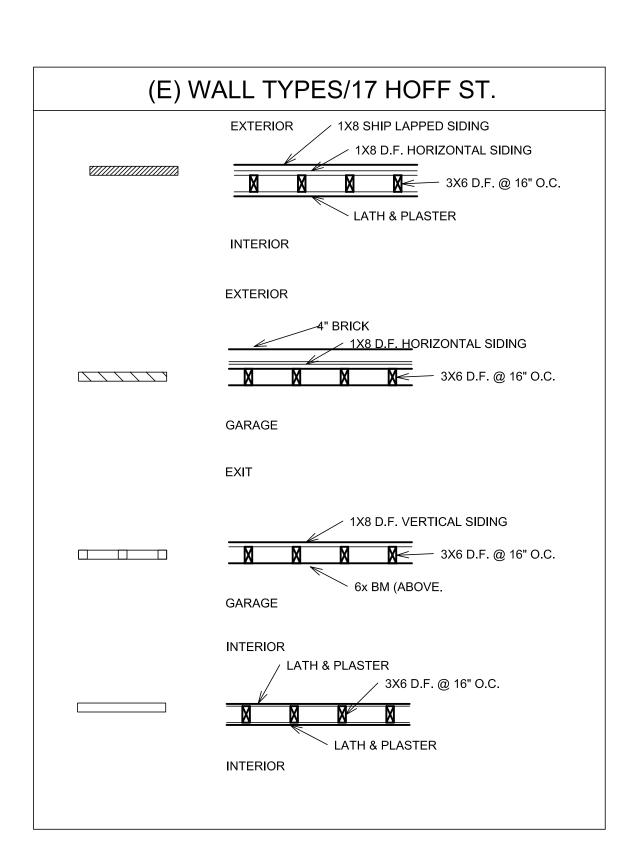


(E) Basement Shear Wall & First Floor Framing Plan 3/16" = 1'-0"

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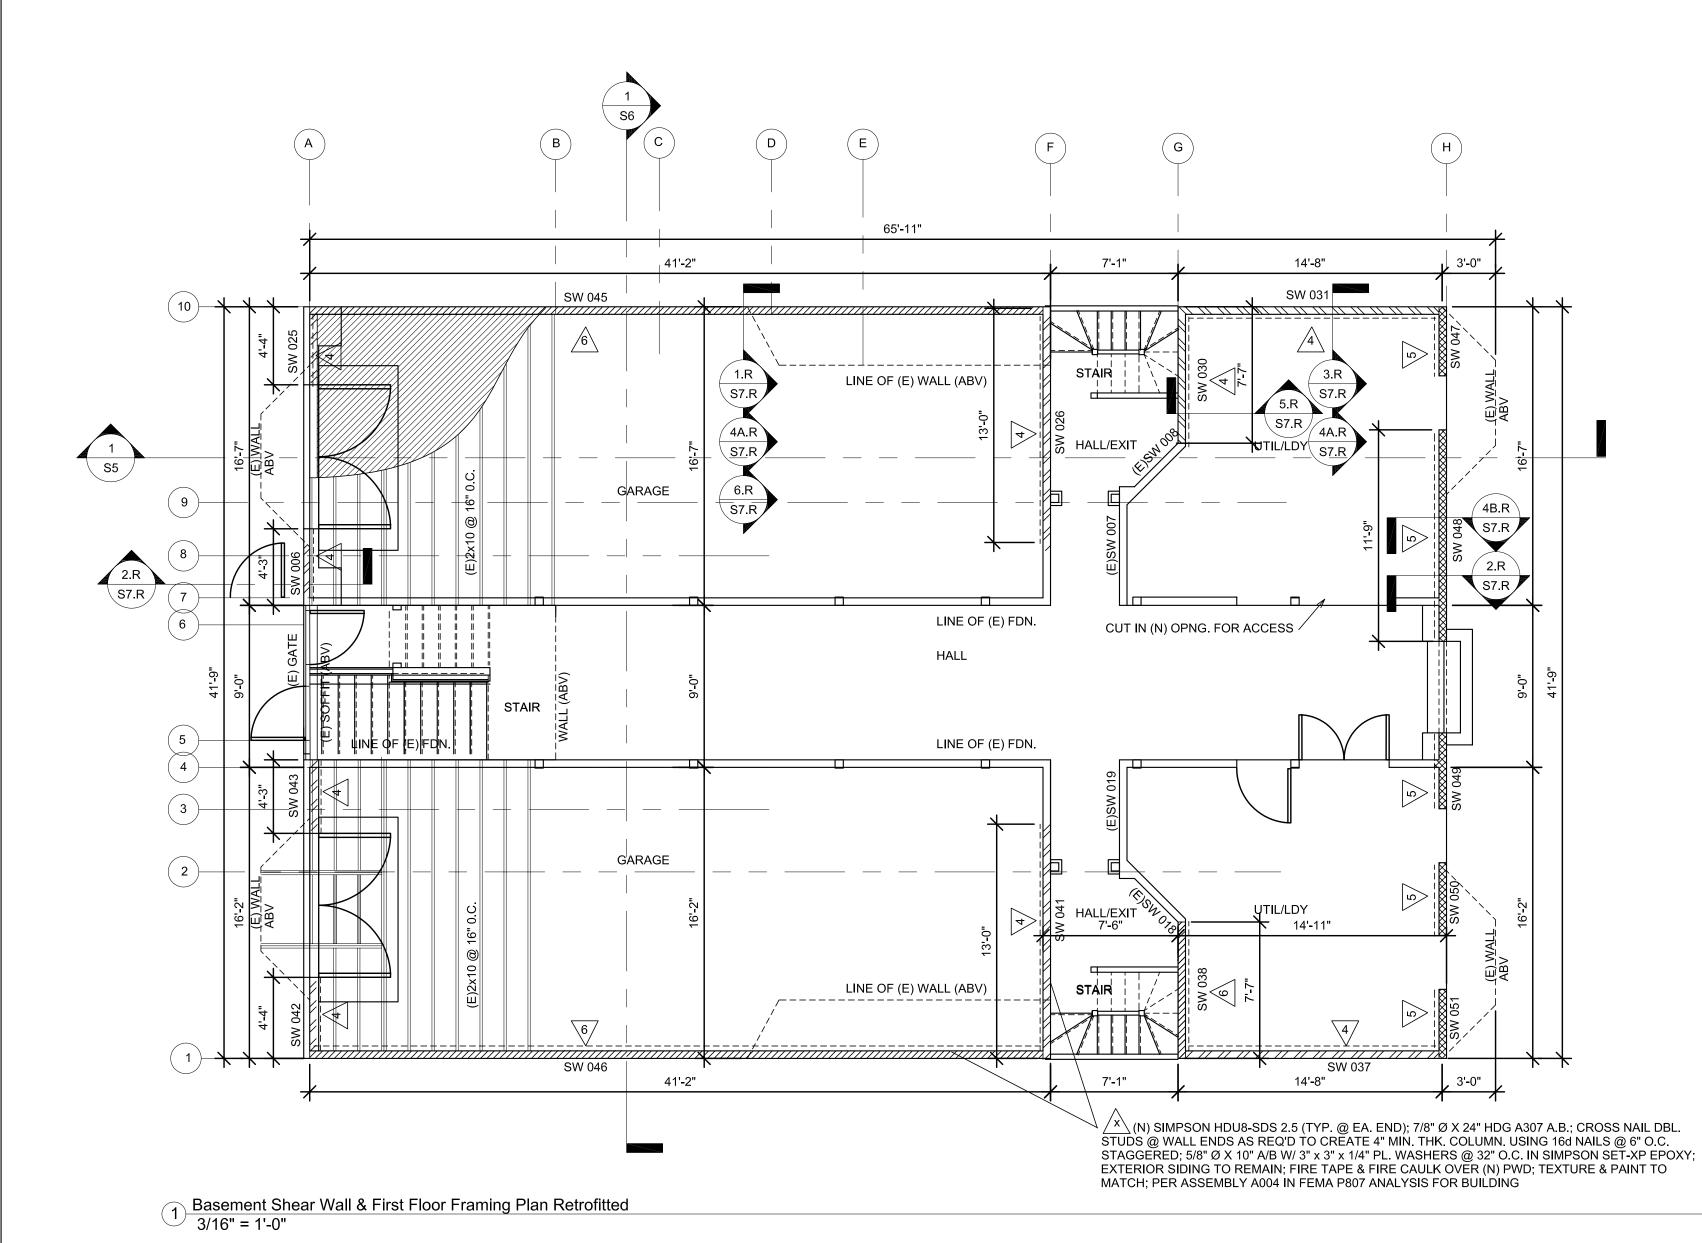
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SOFT-STORY SEISMIC RETROFIT Street Ħ Hol


3/16"

(E) Basement Shear Wall & First Floor Roof Framing Plan

DATE: 5-23-14 DRAWN BY:

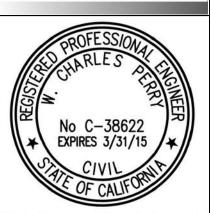


			PHASE I WORK		
ASS'Y#	SH. WALL#	TYPE	PWD & NAILS	HOLDOWNS	STRAP TO (E/N) HEADER
4	SWØØ6 SWØ25 SWØ26 SWØ30 SWØ31 SWØ37 SWØ41 SWØ42	GARAGE EXT-INT STRONG	15/32" STRUCT 1 PWD 10d COMMON NAILS @4" O.C.	SIMPSON HDU8-SDS 2.5 X 6" END POSTS 7/8"Ø X 24" A307 ALL THREAD ROD SET IN SIMPSON SET-XP EPOXY	MST 27 MST 27 MST 27 MST 27 MST 27 MST 27
	SWØ43				MST 27
5	SWØ47 SWØ48 SWØ49 SWØ50 SWØ51	UTIL/STOR. INT-EXT WEAK	15/32" STRUCT 1 PWD 8d COMMON NAILS @ 6" O.C.	SIMPSON HDU8-SDS 2.5 X 6" END POSTS 7/8"Ø X 24" A307 ALL THREAD ROD SET IN SIMPSON SET-XP EPOXY	MST 27 MST 27 MST 27 MST 27 MST 27
6	SWØ38 SWØ45 SWØ46	GARAGE & UTIL. INT-EXT MEDIUM	15/32" STRUCT 1 PWD 10d COMMON NAILS @ 6" O.C.	SIMPSON HDU8-SDS 2.5 X 6" END POSTS 7/8"Ø X 24" A307 ALL THREAD ROD SET IN SIMPSON SET-XP EPOXY	MST 27
			PHASE II WORK		
ASS'Y#	SH. WALL#	TYPE	PWD & NAILS	HOLDOWNS	STRAP TO (E/N) HEADER
<u></u>	SWØØ1 SWØØ4 SWØØ5 SWØØ7 SWØ09 SWØ10 SWØ11 SWØ15 SWØ16 SWØ19 SWØ20 SWØ20 SWØ23 SWØ25 SWØ29	APARTMENT EXT-INT	15/32" STRUCT 1 PWD 10d COMMON NAILS @ 4" O.C.	NONE	NONE
8	SWØ25 SWØ29 SWØ31 SWØ45 SWØ47 SWØ51 SWØ57 SWØ58 SWØ51	APARTMENT INT-INT	15/32" STRUCT 1 PWD 10d COMMON NAILS @ 4" O.C.	NONE	NONE

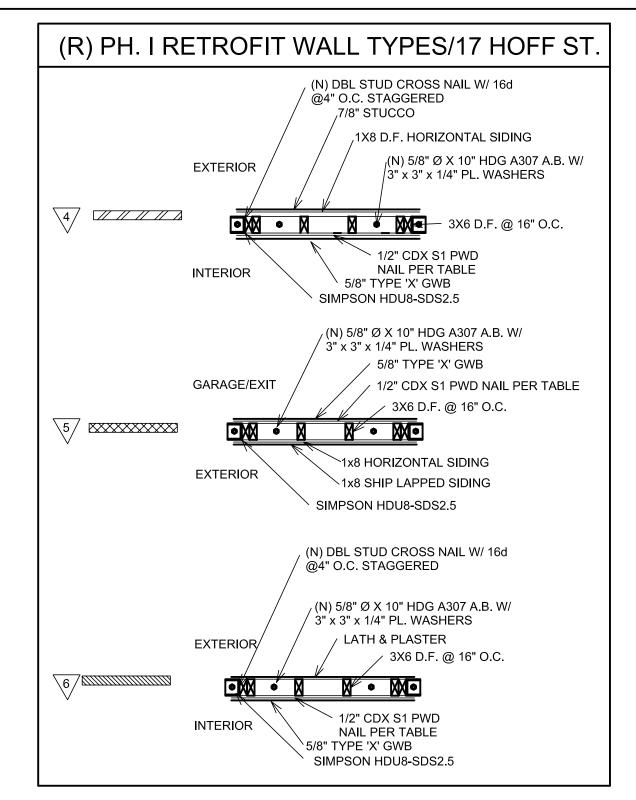

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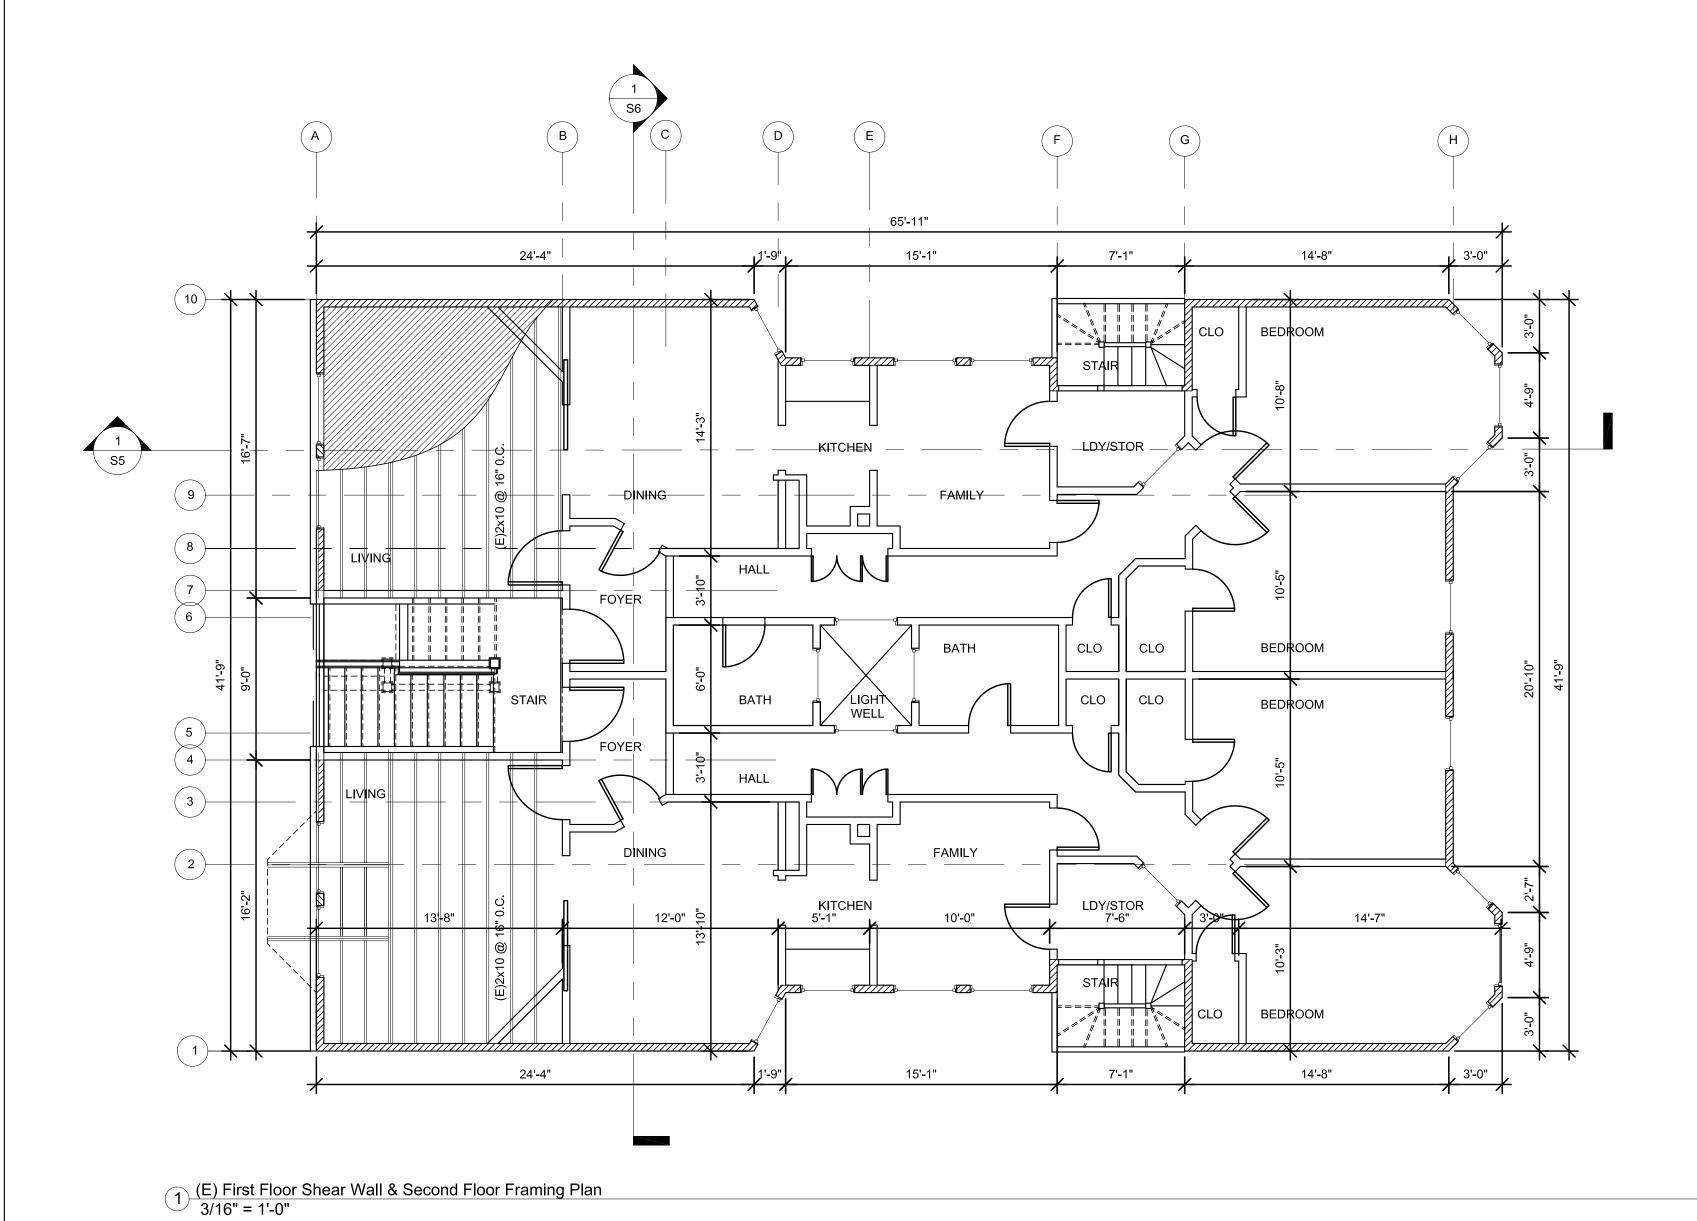
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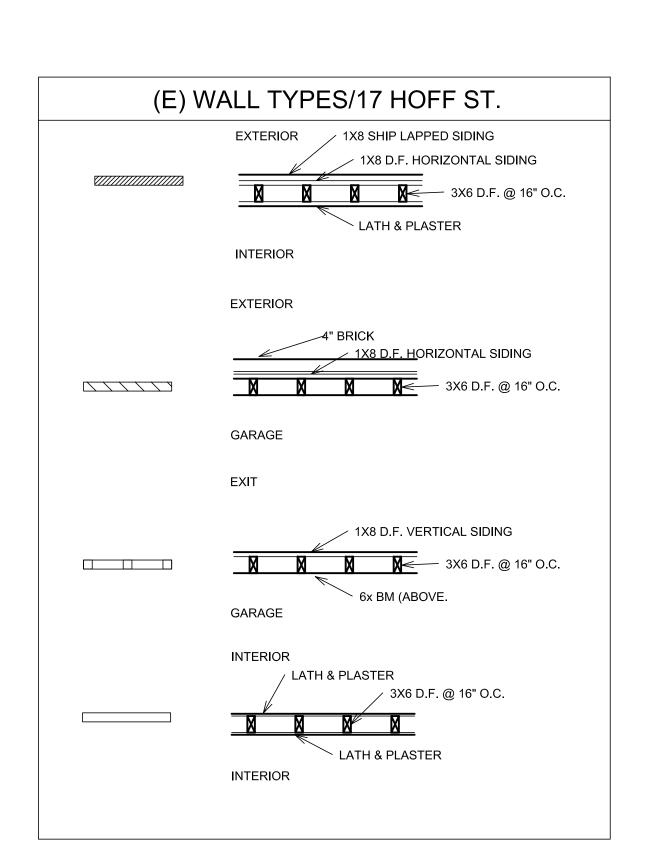
Basement Shear Wall & First Floor Framing Plan Retrofitted

-0-

3/16"

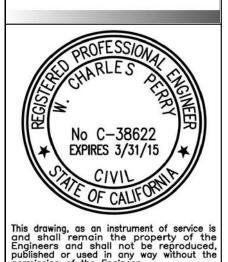DATE: 5-23-14 DRAWN BY:






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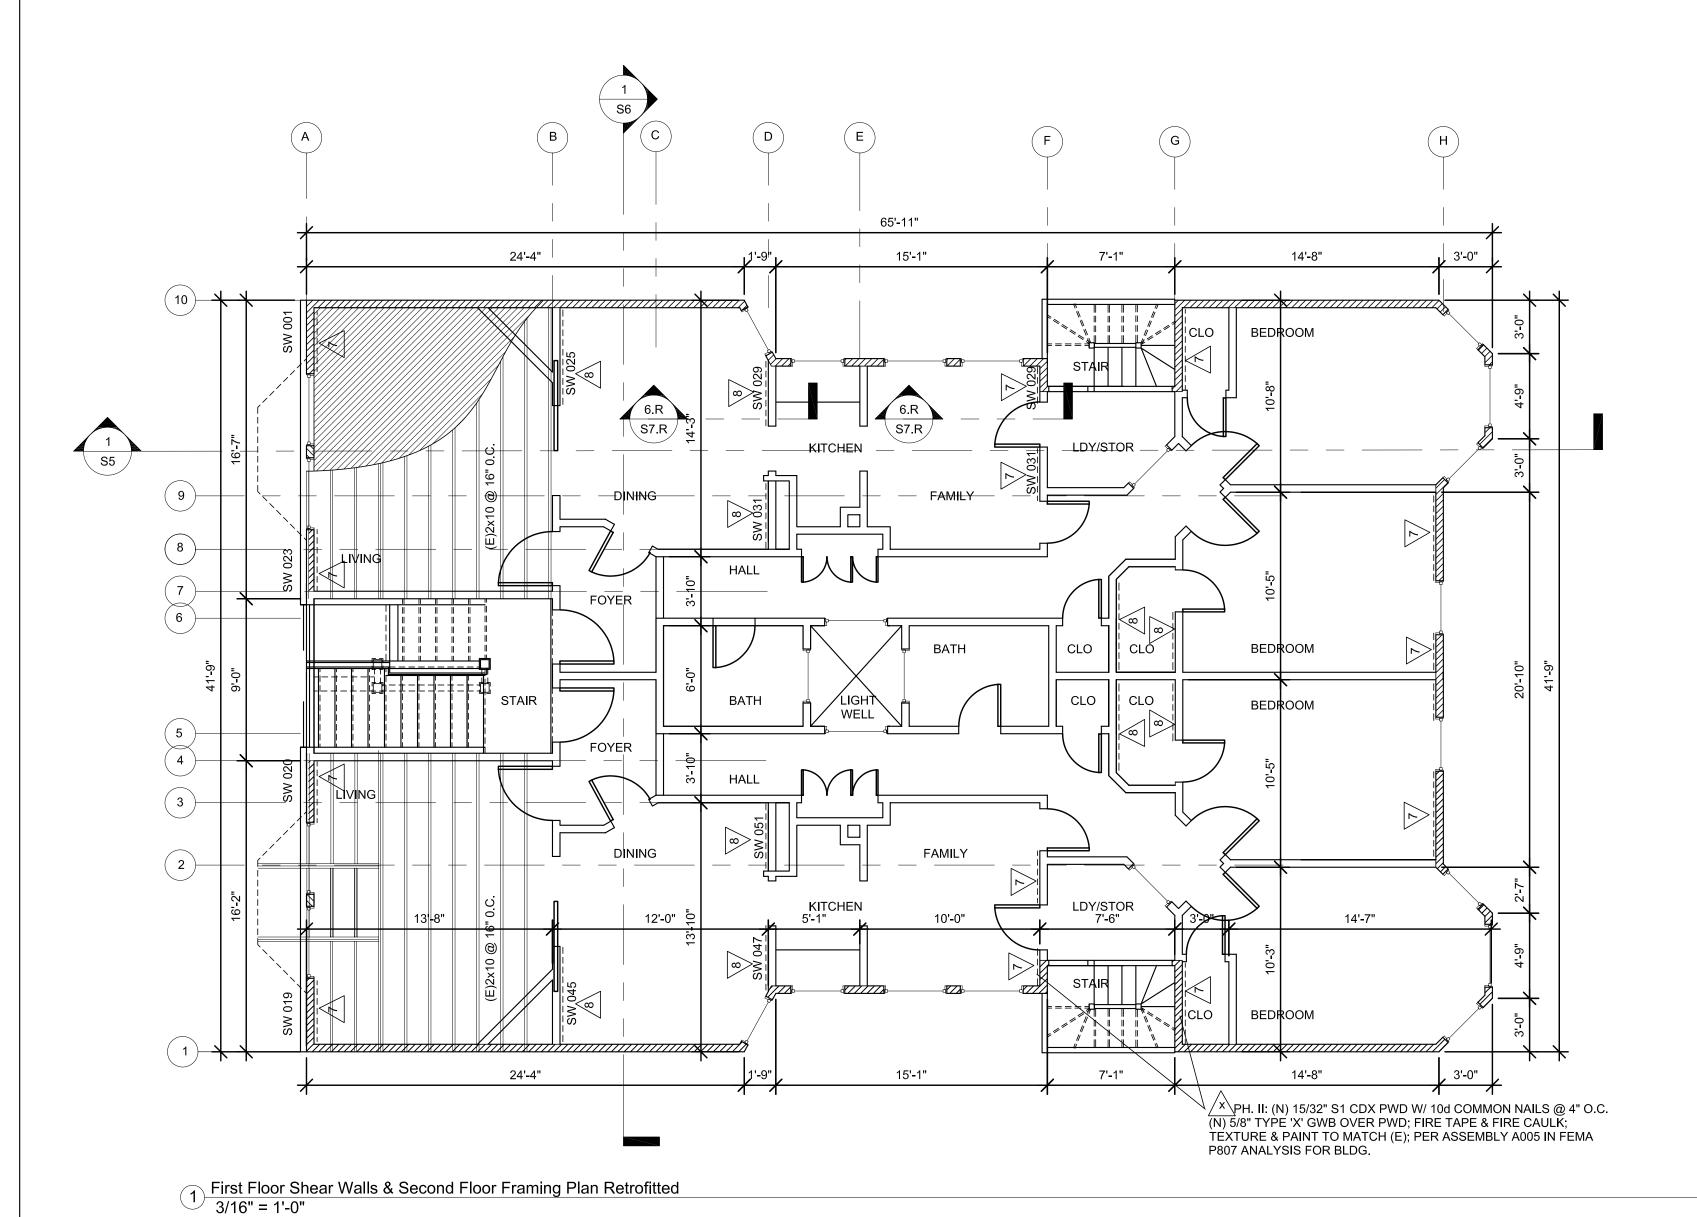
SOFT-STORY SEISMIC RETROFIT Street

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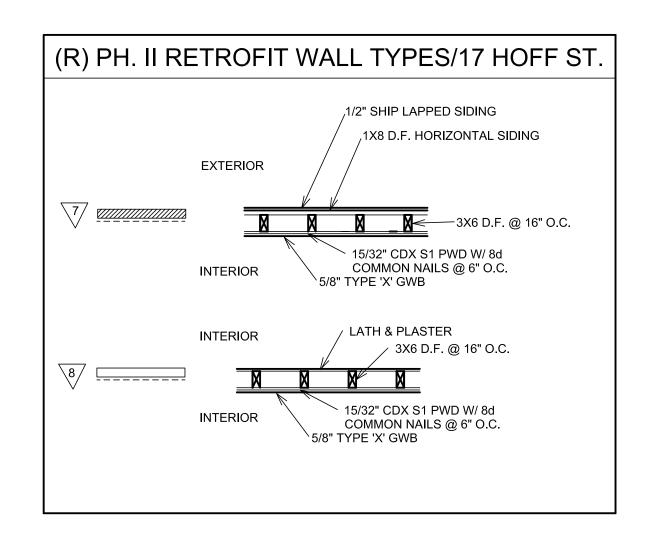
1'-0"

(E) First Floor Shear Wall & Second Floor Framing Plan

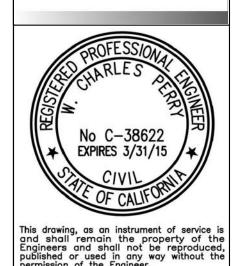DATE: 5-23-14 **DRAWN BY:** DMH



- <u>-</u>			PHASE I WORK		
ASS'Y#	SH. WALL # SWØØ6 SWØ25 SWØ26 SWØ30 SWØ31 SWØ37	GARAGE EXT-INT STRONG	PWD & NAILS  15/32" STRUCT 1 PWD 10d COMMON NAILS @4" O.C.	HOLDOWNS  SIMPSON HDU8-SDS 2.5 X 6" END POSTS 7/8"Ø X 24" A307 ALL THREAD ROD SET IN SIMPSON SET-XP	MST 27 MST 27 MST 27 MST 27 MST 27 MST 27
	SWØ41 SWØ42 SWØ43			EPOXY	MST 27 MST 27 MST 27
5	SWØ47 SWØ48 SWØ49 SWØ50 SWØ51	UTIL/STOR. INT-EXT WEAK	15/32" STRUCT 1 PWD 8d COMMON NAILS @ 6" O.C.	SIMPSON HDU8-SDS 2.5 X 6" END POSTS 7/8"Ø X 24" A307 ALL THREAD ROD SET IN SIMPSON SET-XP EPOXY	MST 27 MST 27 MST 27 MST 27 MST 27
6	SWØ38 SWØ45 SWØ46	GARAGE & UTIL. INT-EXT MEDIUM	15/32" STRUCT 1 PWD 10d COMMON NAILS @ 6" O.C.	SIMPSON HDU8-SDS 2.5 X 6" END POSTS 7/8"Ø X 24" A307 ALL THREAD ROD SET IN SIMPSON SET-XP EPOXY	MST 27
۸ <u> </u>	CII WALL#	TVDE	PHASE II WORK PWD & NAILS	HOLDOWNS	STRAP TO (E/N) HEADER
ASS'Y#	SH. WALL # SWØØ1 SWØØ4 SWØØ5 SWØØ7 SWØØ9 SWØ10 SWØ11 SWØ13 SWØ15 SWØ16 SWØ19 SWØ20 SWØ20 SWØ23 SWØ25 SWØ29	APARTMENT EXT-INT	15/32" STRUCT 1 PWD 10d COMMON NAILS @ 4" O.C.	NONE	NONE
8	SWØ25 SWØ29 SWØ31 SWØ45 SWØ47 SWØ51 SWØ57 SWØ58 SWØ51	APARTMENT INT-INT	15/32" STRUCT 1 PWD 10d COMMON NAILS @ 4" O.C.	NONE	NONE



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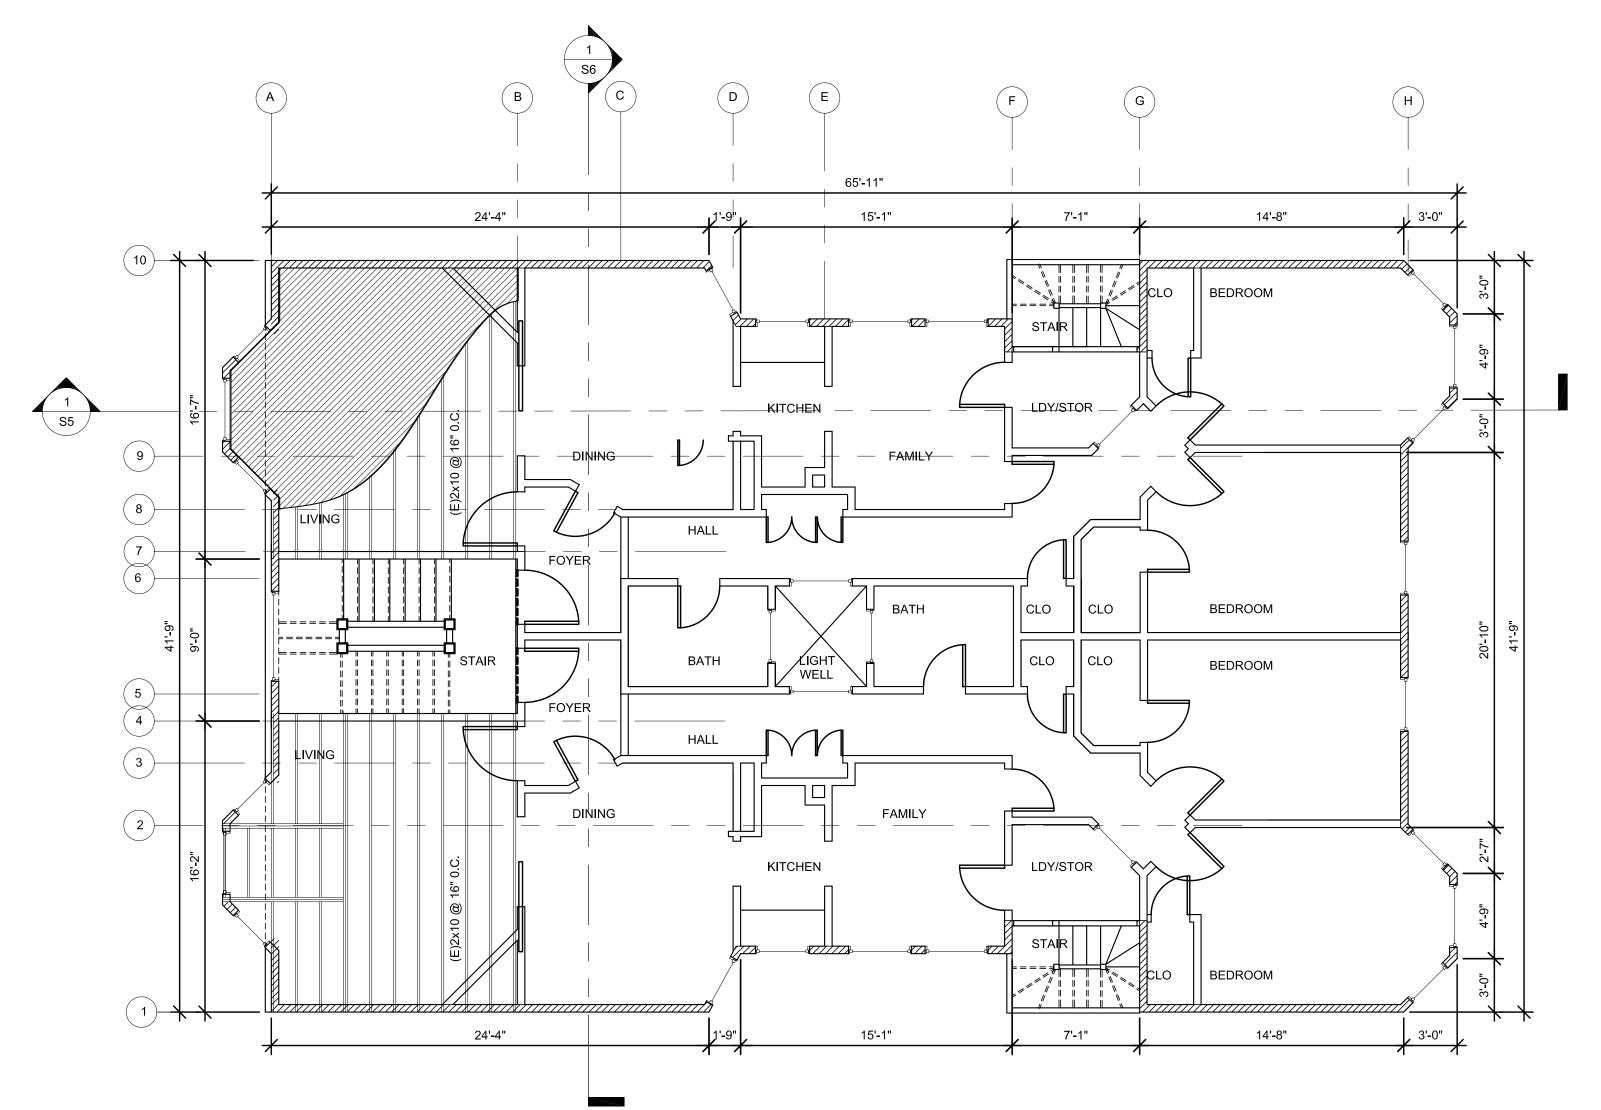
First Floor Shear Wall & Second Floor Framing Plan Retrofitted - Phase II


3/16"

SOF

DATE:

5-23-14 DRAWN BY:



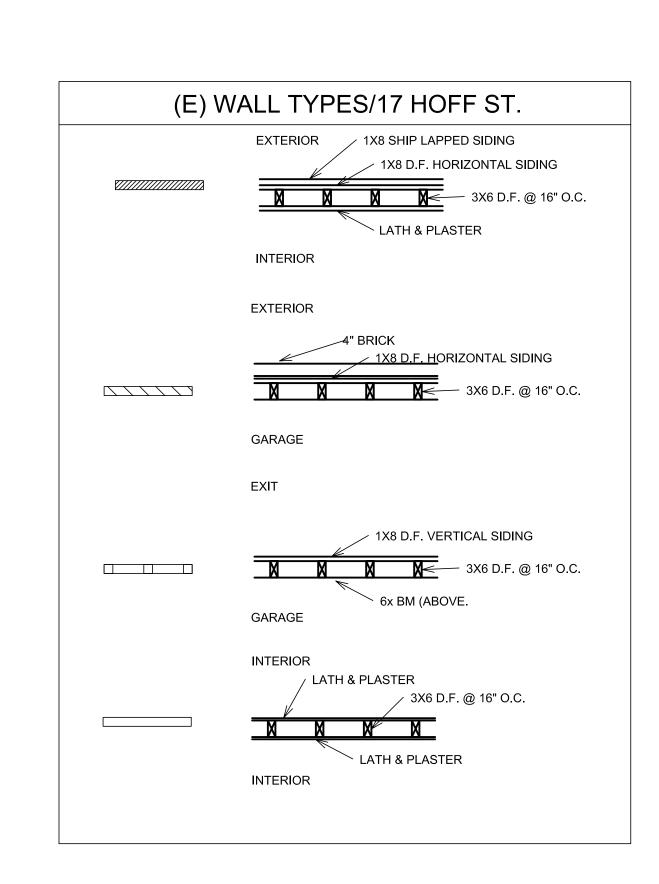


1 Second Floor Shear Wall & Third Floor Framing Plan 3/16" = 1'-0"

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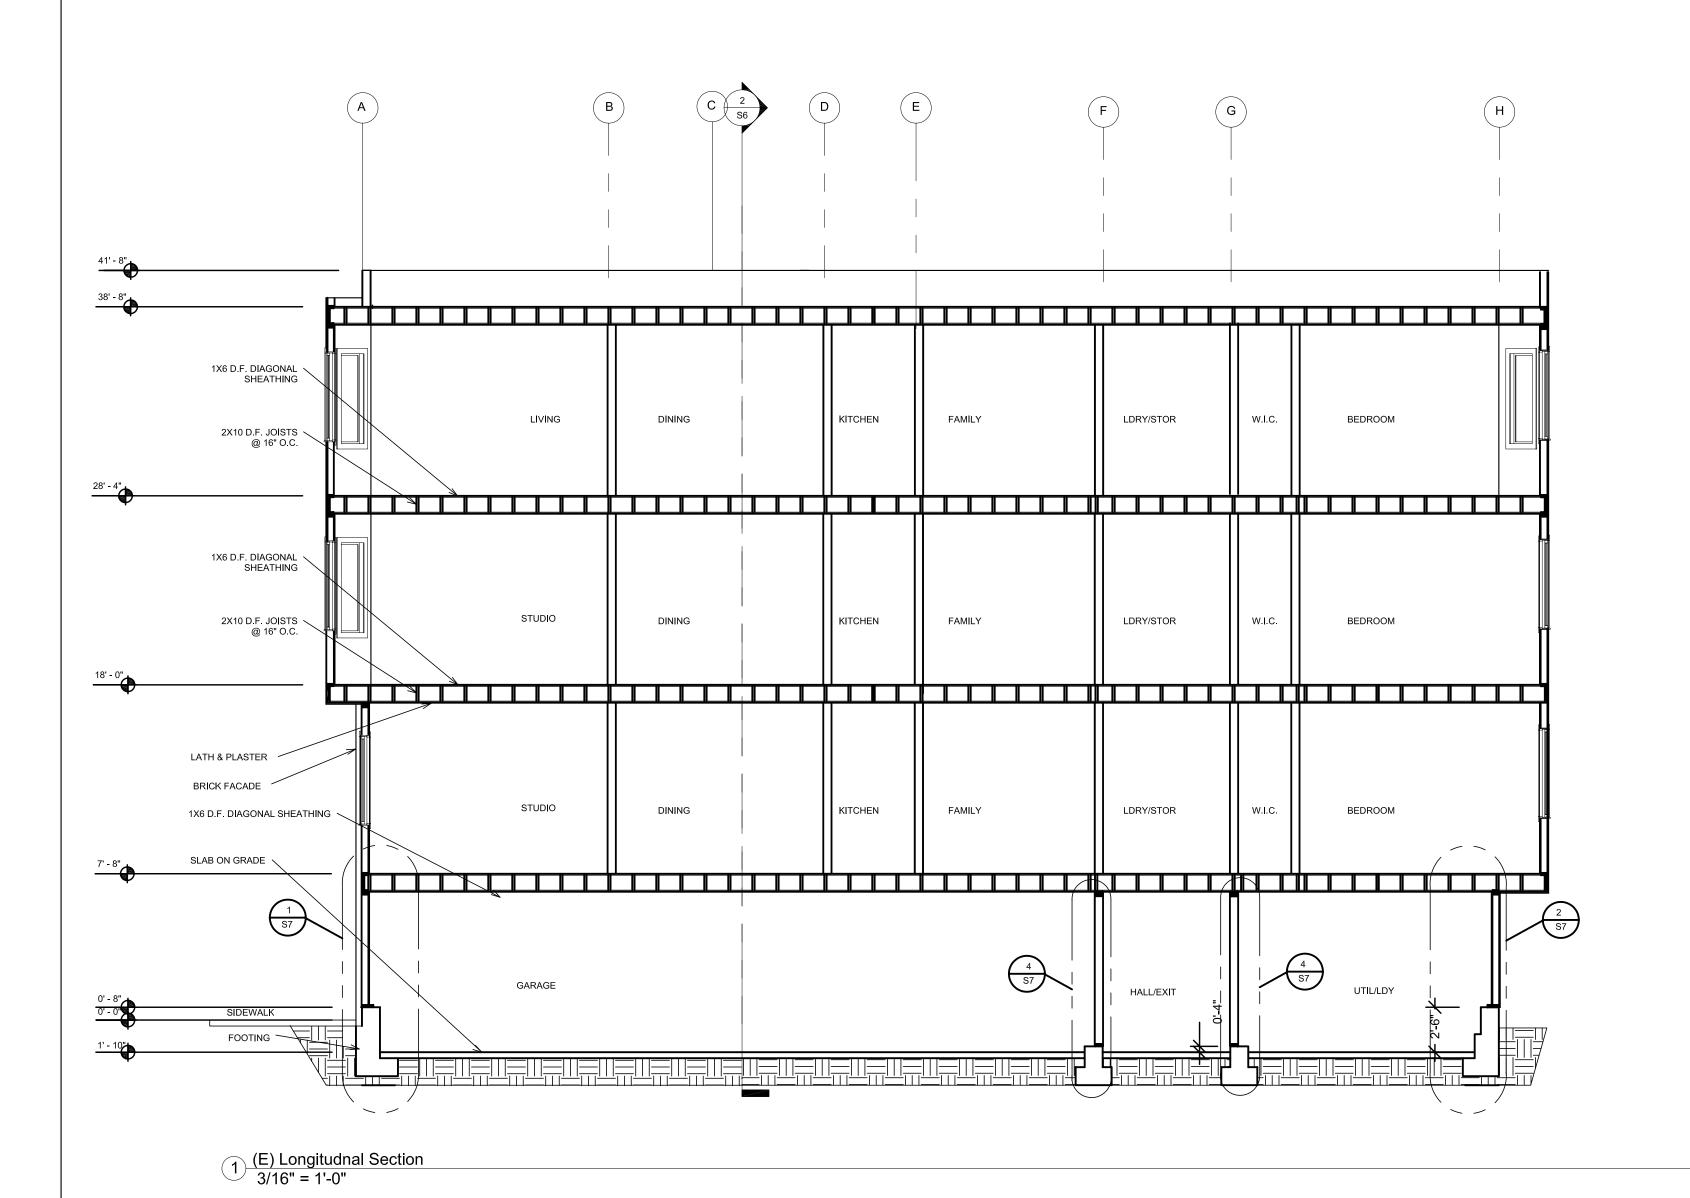
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Street T-STORY S

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(E) Second Floor Shear Wall & Third Floor Framing Plan 1'-0" 3/16"


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SOFT-STORY SE 17 Hof

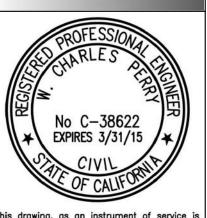
E) Longitudnal Section 3/16" = 1'-0"

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 5-23-14

 DRAWN BY:
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SOFT-STORY S


Longitudnal Section
Retrofitted

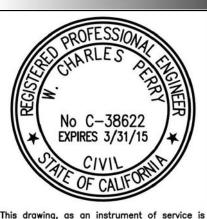 DATE:
 5-23-14

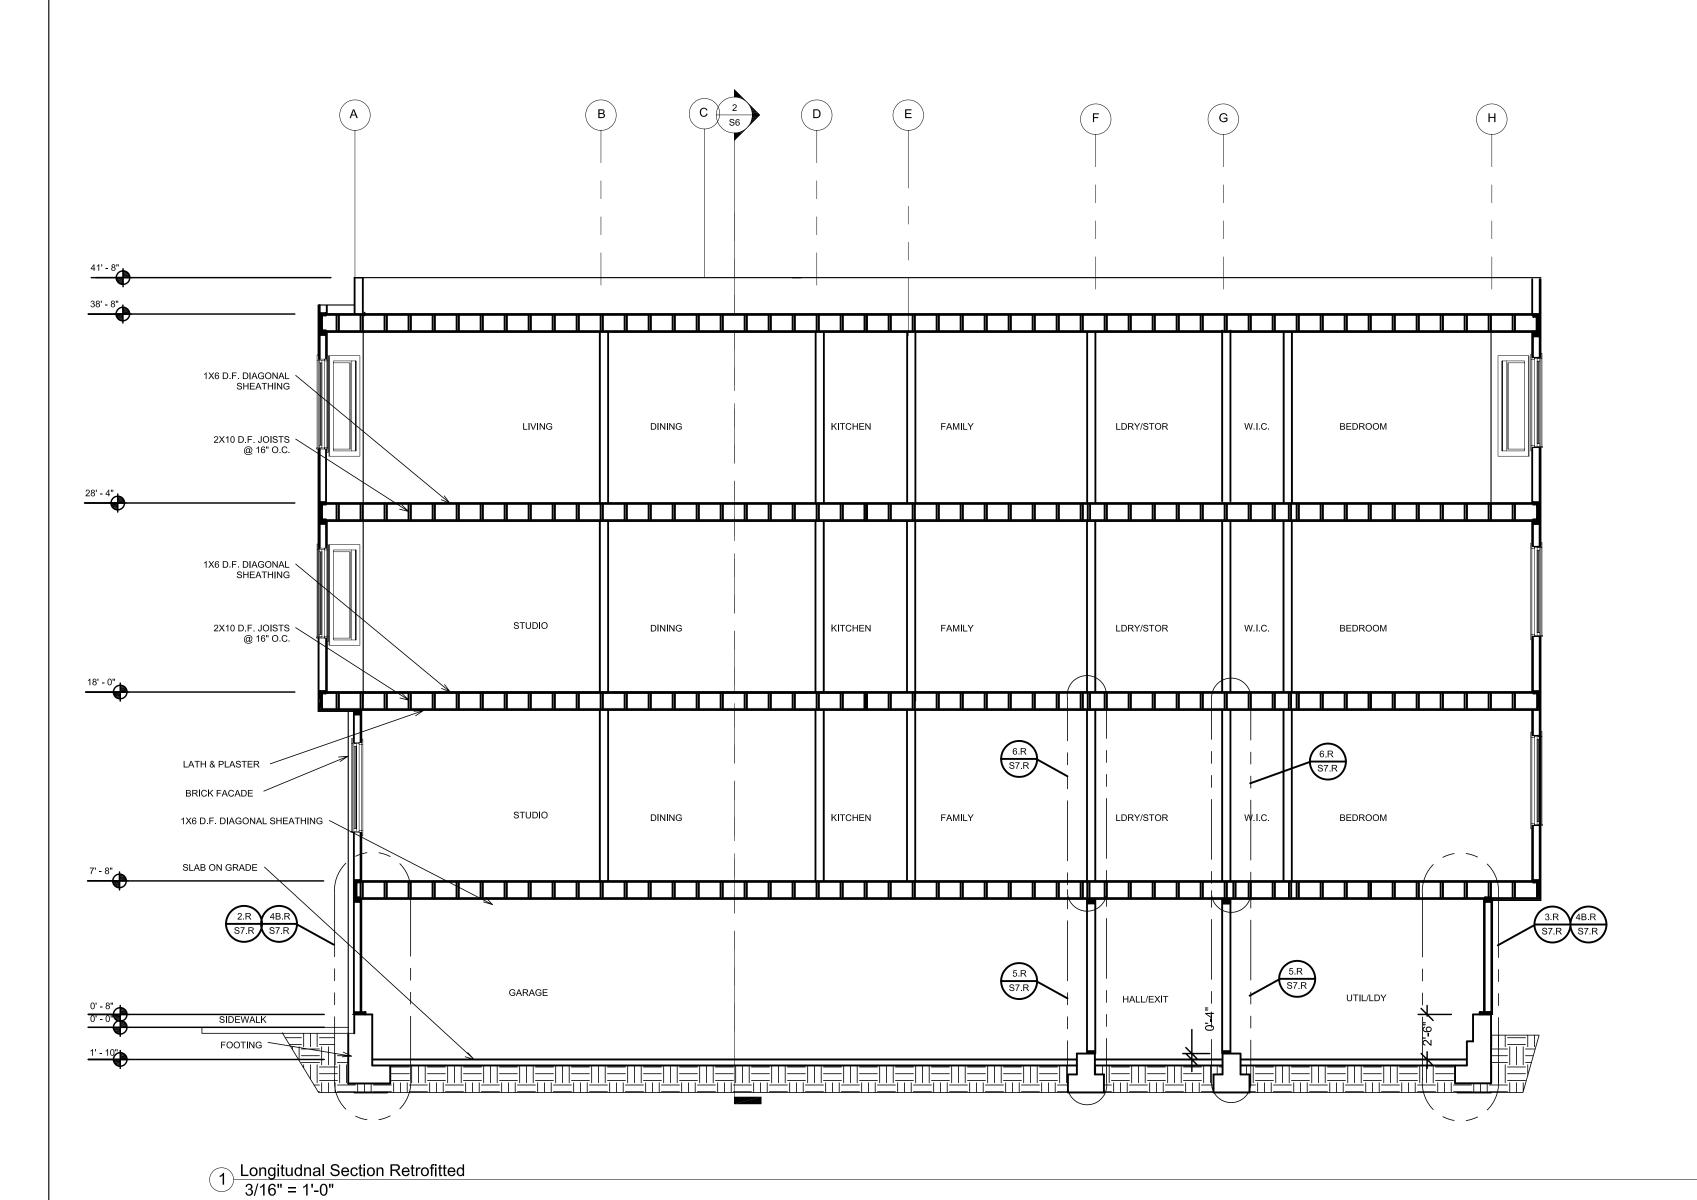 DRAWN BY:
 DMH

JOB #:

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r-story seismic retrofit I 7 Hoff Street

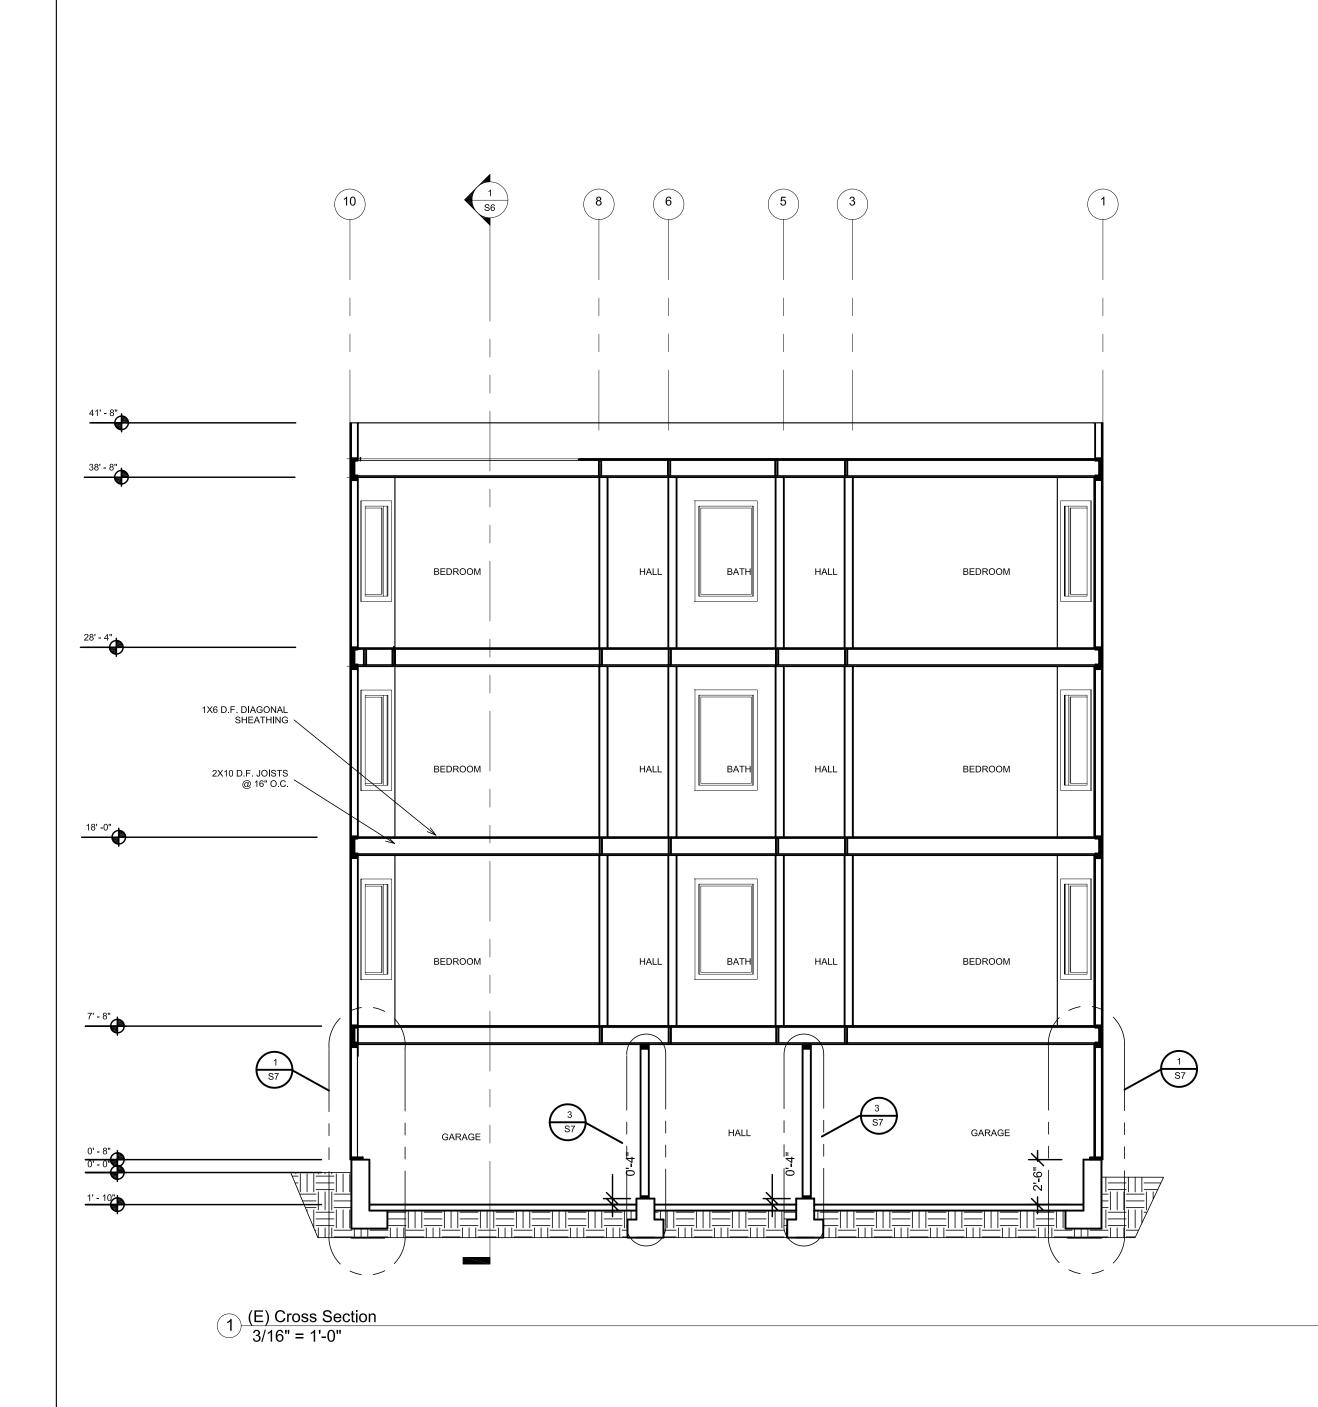
3/16" = 1'-0"

**DATE:** 5-23-14

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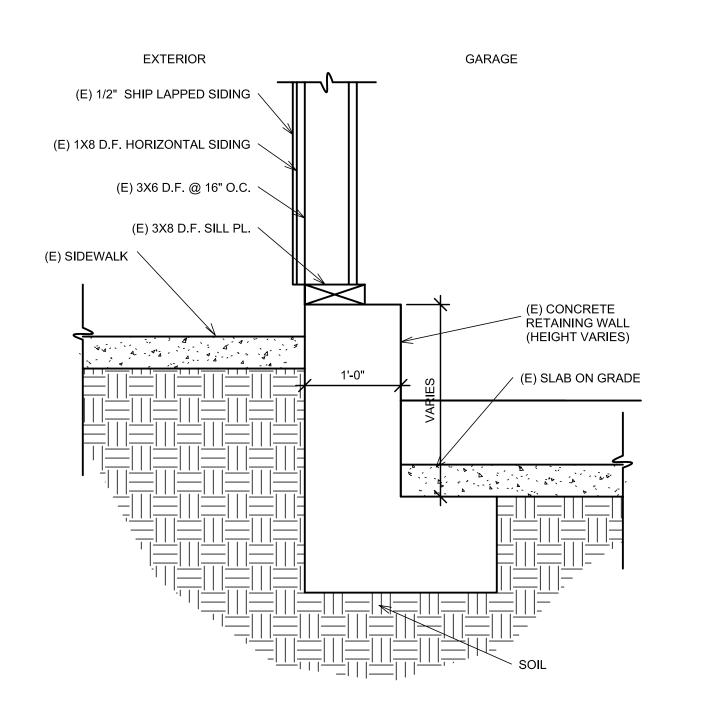
SOFT-STORY SEISMIC RETROFIT Ħ


Section Retrofitted

DATE: 5-23-14 DRAWN BY:

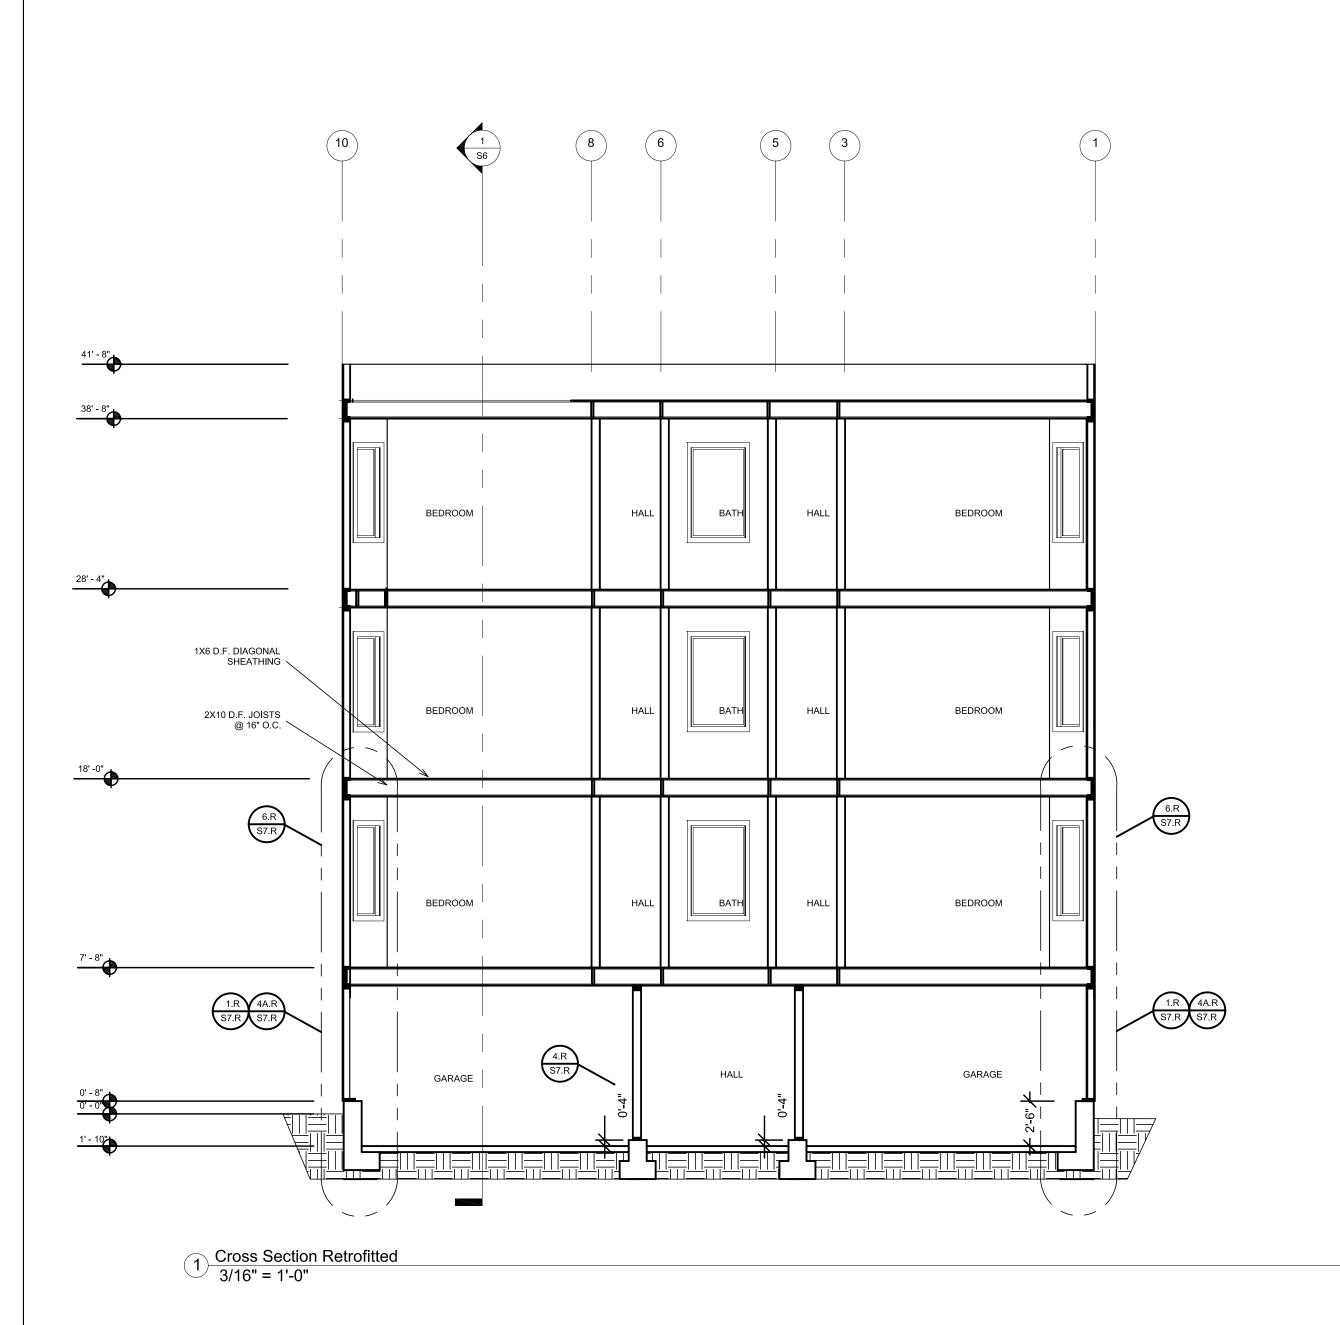
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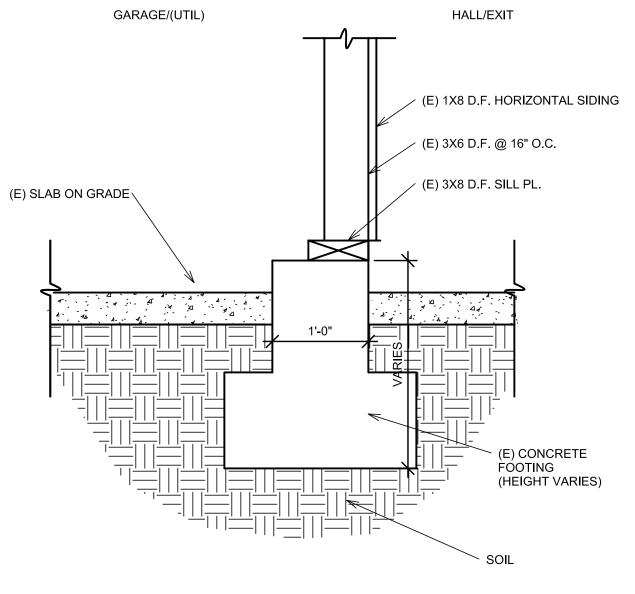


2 Detail 2 1" = 1'-0"

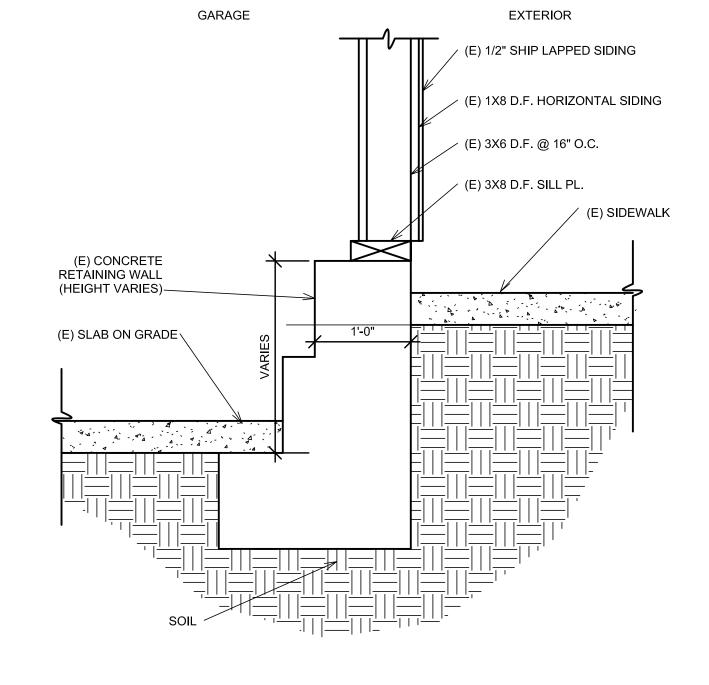


1 Detail 1 1" = 1'-0"

3 Detail 3 1" = 1'-0"

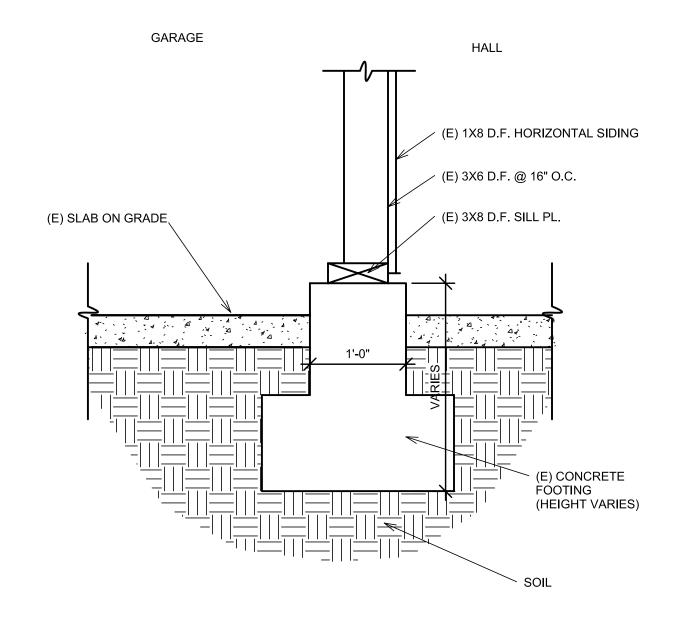


4 Detail 4 1" = 1'-0"


**REVISIONS** NO. DATE W. CHARLES PERRY & **ASSOCIATES** 231 W. 41ST AVENUE SAN MATEO, CA 94403 650-638-9546 No C−38622 EXPIRES 3/31/15 **DRAWINGS ARE HALF SCALE** AND NOT FOR CONSTRUCTION **WHEN SHOWN ON 11X17 OR NOT WET** SIGNED AND **DATED** STORY SEISMIC RETROFIT Stre Hoff 17 Hof Francis SOF Details <u>-</u>0 oundation DATE: 5-23-14 **DRAWN BY:** DMH

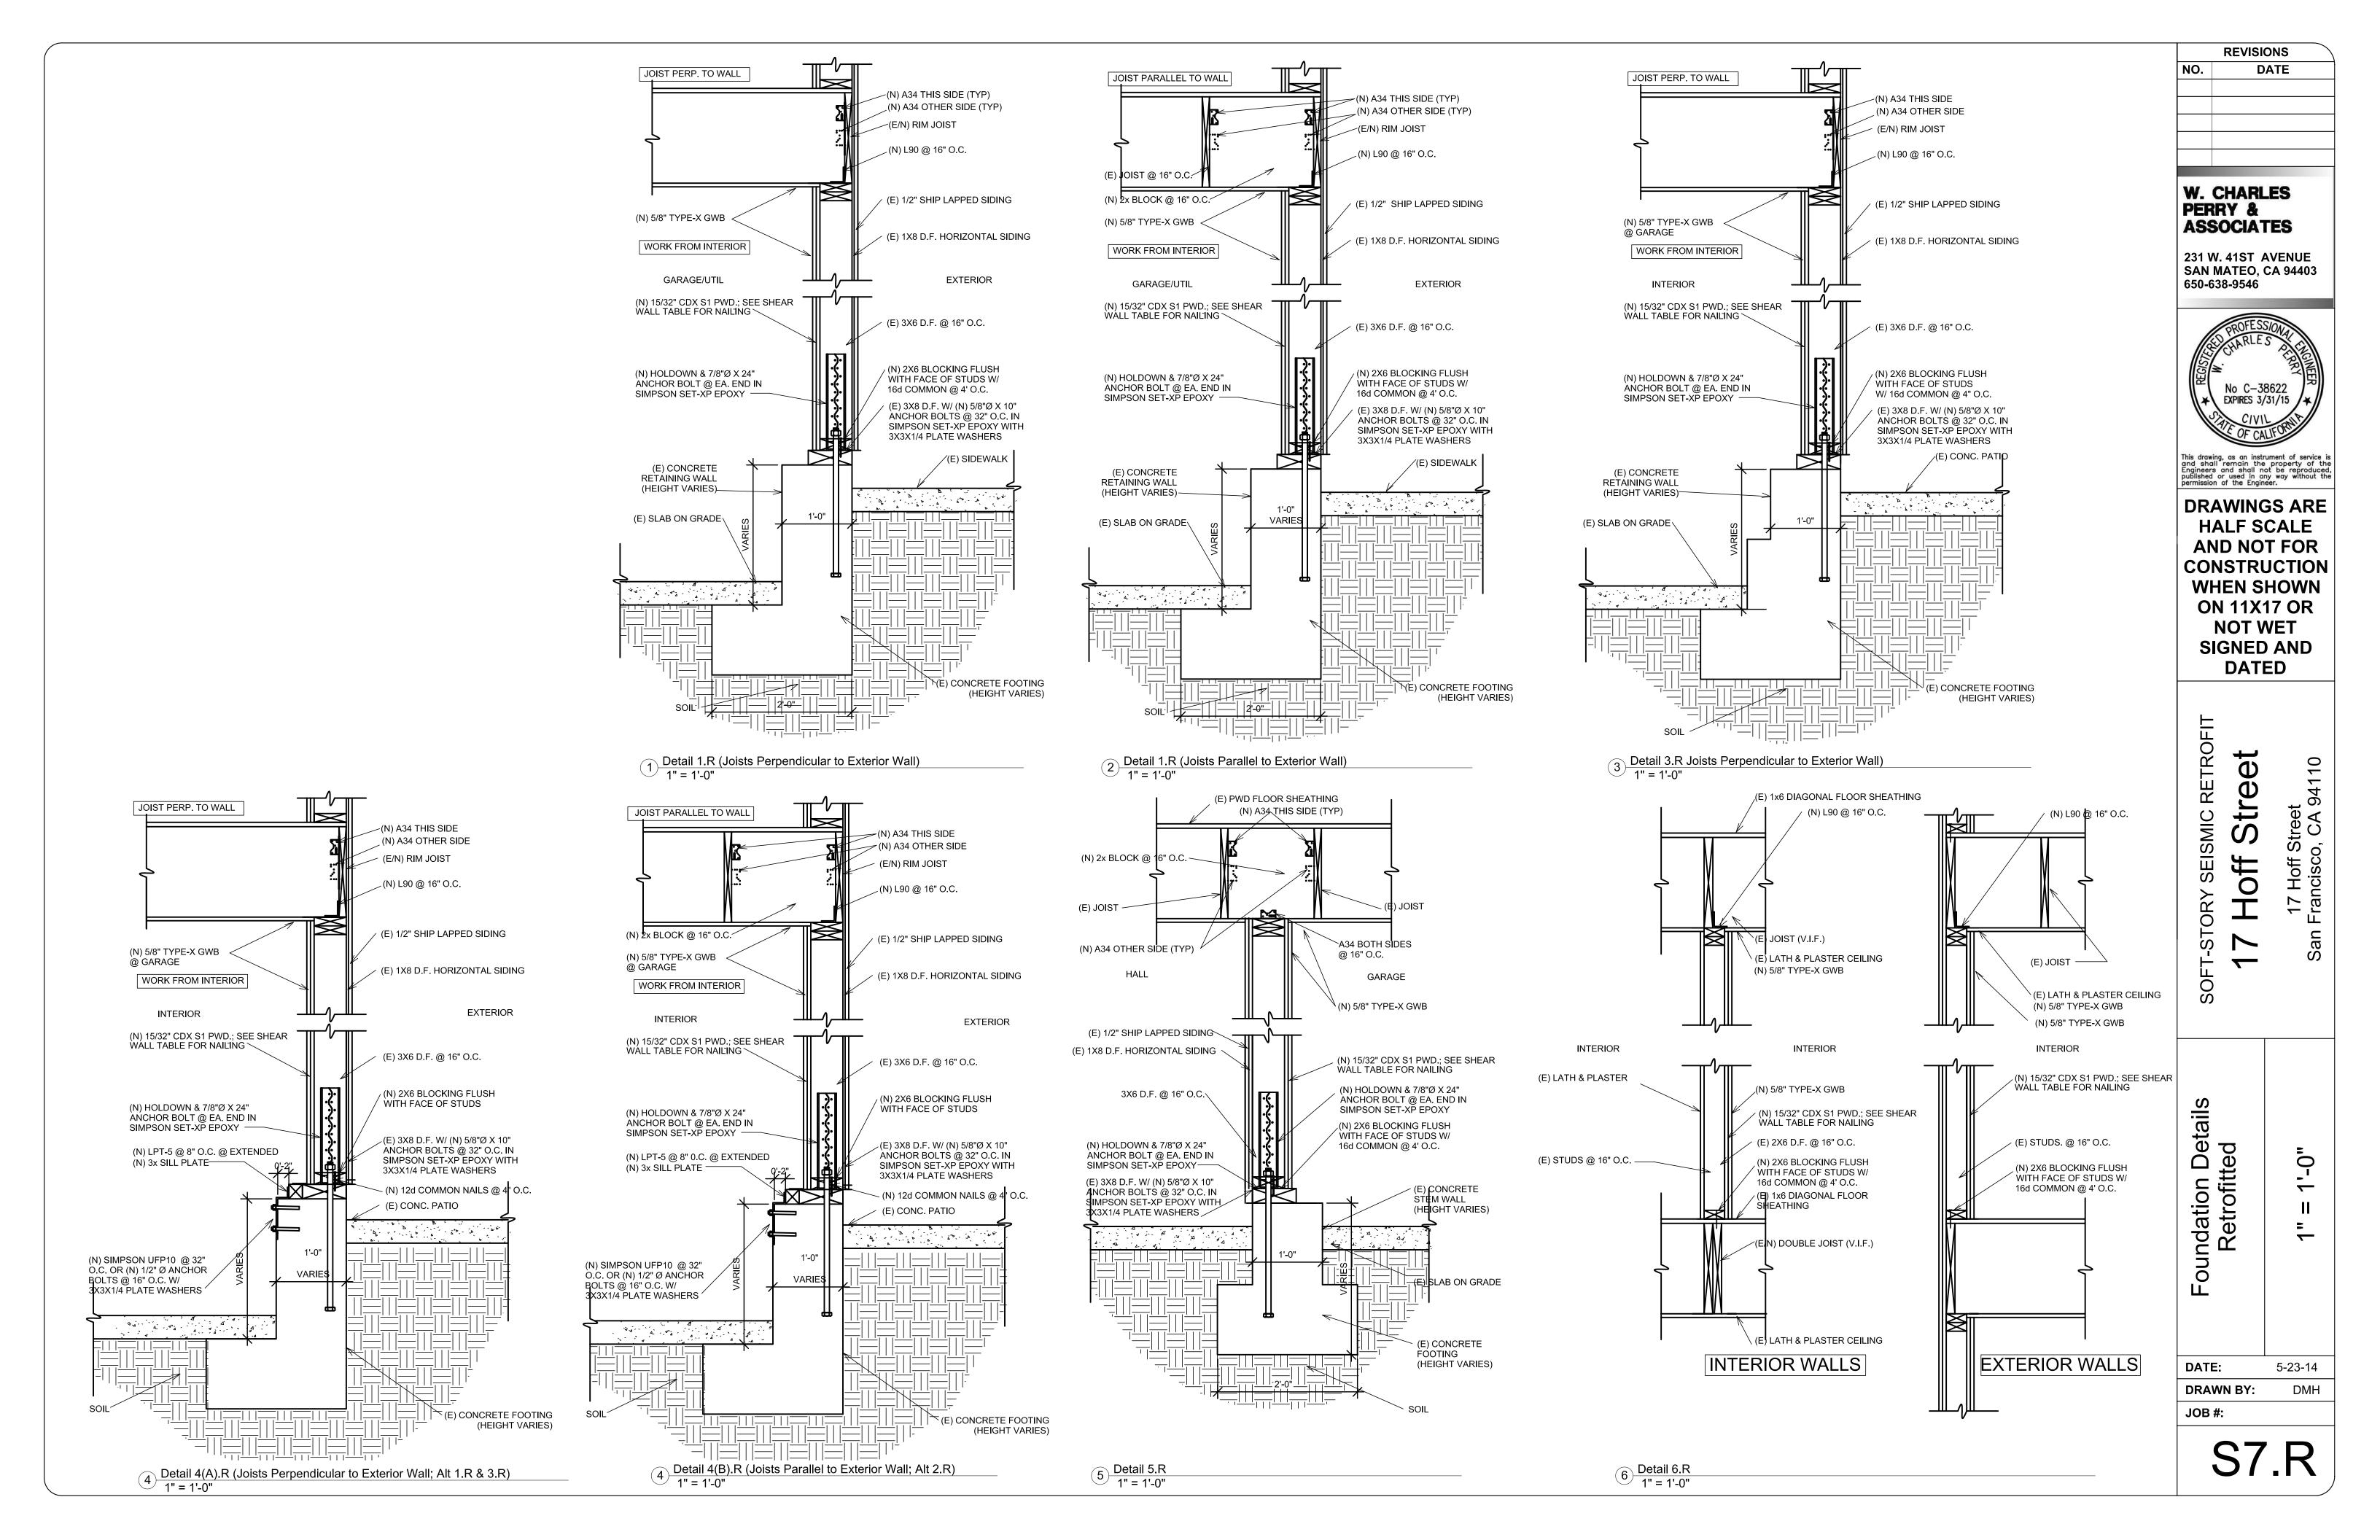


1) TYPICAL CRIPPLE WALL BRACING DETAIL

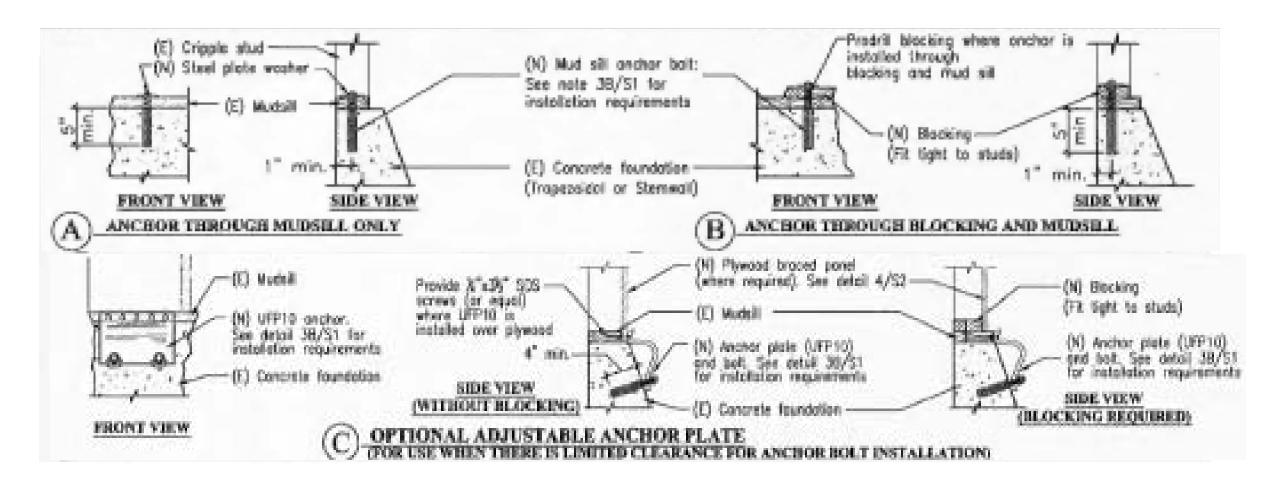


2 TYPICAL MUDSILL TO CONCRETE FOUNDATION CONNECTIONS

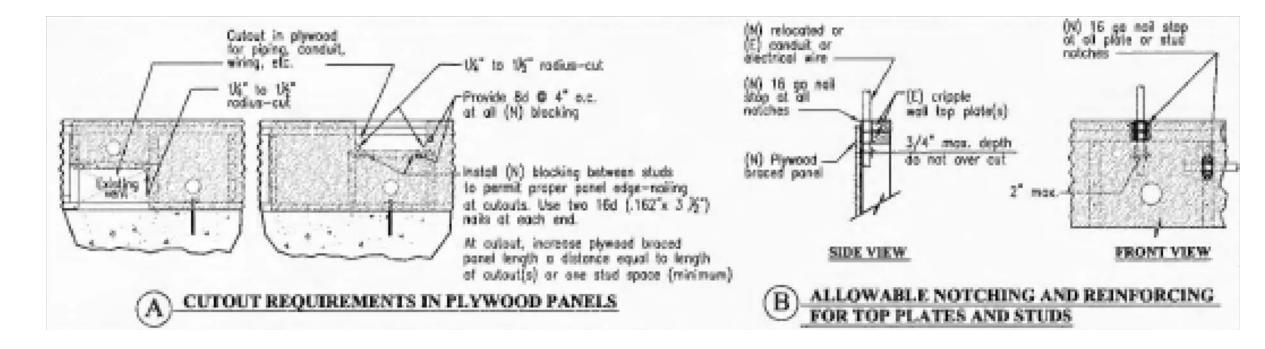


3 TYPICAL PANEL CUTOUTS & NOTCHING REQUIREMENTS

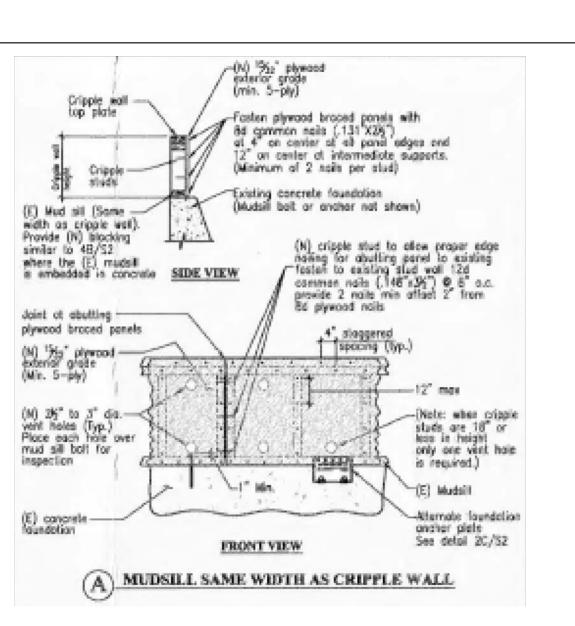

4 PLYWOOD BRACED PANEL INSTALLATION DETAIL

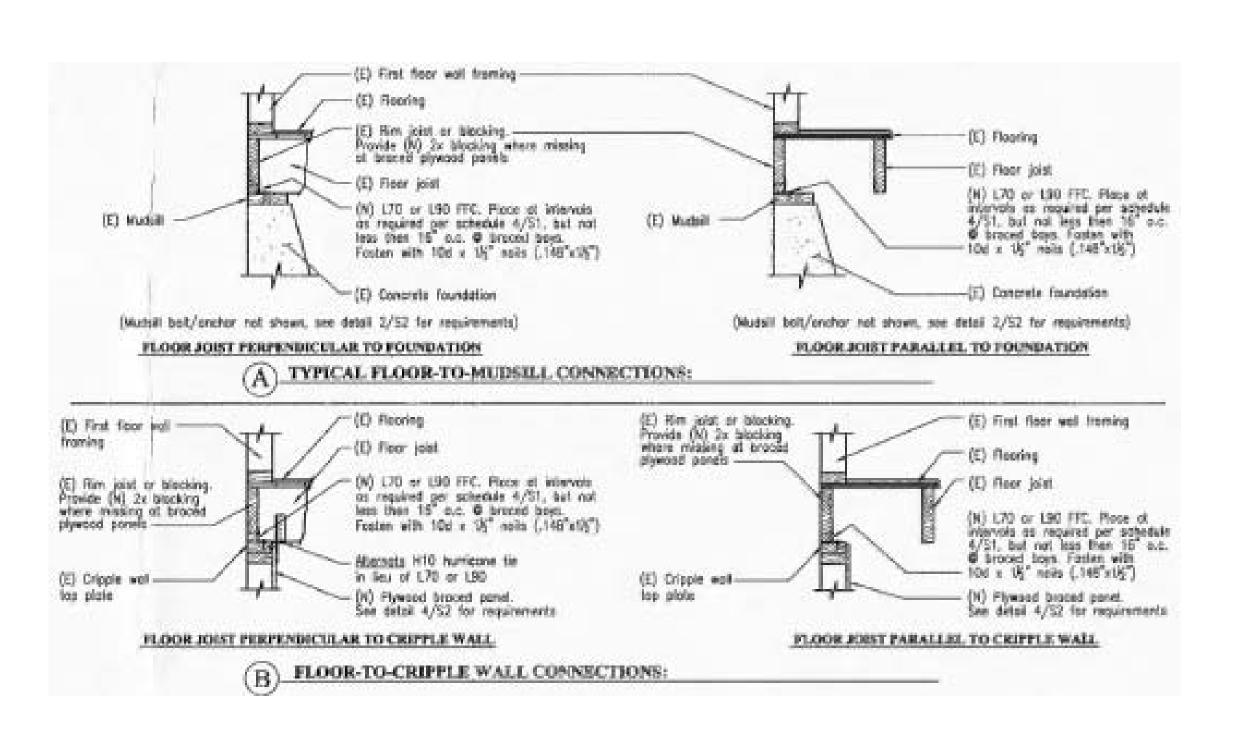

TYPICAL FLOOR-TO-CRIPPLE WALL OR FLOOR-TO-MUDSILL CONNECTIONS

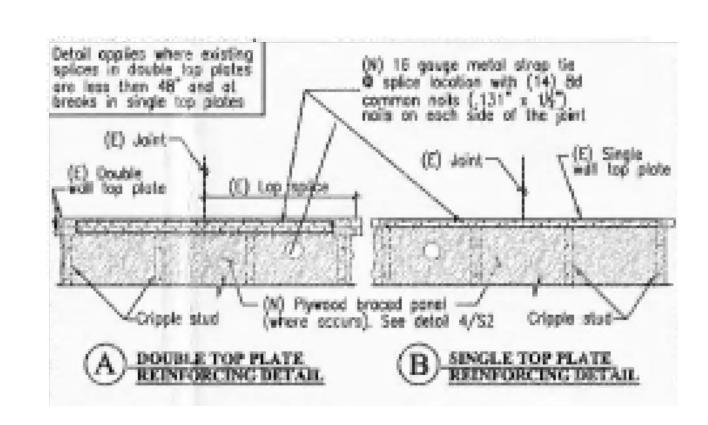

6 TYPICAL TOP PLATE SPLICE DETAILS

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